Date: September 25, 2025

To: Plan Holders

From: University of Southern Mississippi

Subject: ADDENDUM No. 2

Library Plaza and Forrest Avenue Pedestrian Plaza Phase II

STP-0210-00(044) LPA / 109418-711000

Forrest County, Mississippi

Attached is Addendum No. 2 for the above referenced project.

Plan Holders are reminded that this Addendum must be acknowledged on Page 905-2.

Contract Documents

- 1. Replace SECTION 905 PROPOSAL (CONTINUED) with attached **SECTION 905-PROPOSAL (CONTINUED).** (2 sheets)
- 2. Replace SECTION 905 BID SCHEDULE with attached **SECTION 905 BID SCHEDULE**. (6 sheets).
- 3. Replace Wage Rates with attached **Wage Rates**.

Construction Plans

1. Remove and replace the following plan sheets in their entirety with the included plan sheets:

Drawing Number 3 | Working Numbers SQ-1

Drawing Number 4 | Working Numbers SQ-2

Drawing Number 5 | Working Numbers SQ-3

Drawing Number 21 | Working Number LS-2

Drawing Number 23 | Working Number LS-4

Drawing Number 30 | Working Number ESP-1

Drawing Number 31 | Working Number ESP-2

Drawing Number 32 | Working Number ESP-3

Drawing Number 33 | Working Number ED-1

Drawing Number 34 | Working Number ED-2

Drawing Number 35 | Working Number ED-3

Drawing Number 36 | Working Number ED-4

Drawing Number 38 | Working Number EQL-1

Drawing Number 39 | Working Number S-1

Drawing Number 42 | Working Number DET-2

You should receive (32) pages **including this cover sheet.** Please notify us if the message is incomplete or unclear. Thank you.

Last Edited 6/12/2018

SECTION 905 - PROPOSAL

TO:	
	owing proposal is made on behalf of of
	ng the following designated project(s) within the time(s) hereinafter specified. ans are composed of drawings and blue prints on file in the offices of
approved	, Mississippi. ccifications are the current Standard Specifications of the Mississippi Department of Transportation he Federal Highway Administration, except where superseded or amended by the plans, Special I Notice(s) to Bidders attached hereto and made a part thereof.

I (We) certify that I (we) possess a copy of said Standard and any Supplemental Specifications.

Evidence of my (our) authority to submit the Proposal is hereby furnished. The proposal is made without collusion on the part of any person, firm or corporation. I (We) certify that I (we) have carefully examined the Plans, the Specifications, including the Special Provisions and Notice(s) to Bidders, herein, and have personally examined the site of the work. On the basis of the Specifications, Special Provisions, Notice(s) to Bidders, and Plans, I (we) propose to furnish all necessary machinery, tools, apparatus and other means of construction and do all the work and furnish all the materials in the manner specified. I (We) understand that the quantities mentioned herein are approximate only and are subject to either increase or decrease, and hereby propose to perform any increased or decreased quantities of work at the unit prices bid, in accordance with the above.

I (We) acknowledge that this proposal will be found irregular and/or non-responsive unless	a certified
check, cashier's check, or Proposal Guaranty Bond in the amount as required in the Advertisement (o	or, by law)
is submitted electronically with the proposal or is delivered to the office of	located at
prior to the bid opening time specified in the advertisement.	

INSTRUCTION TO BIDDERS: Alternate and Optional Items on Bid Schedule.

- 1. Two or more items entered opposite a single unit quantity WITHOUT DEFINITE DESIGNATION AS "ALTERNATE ITEMS" are considered as "OPTIONAL ITEMS". Bidders may or may not indicate on bids the Optional Item proposed to be furnished or performed WITHOUT PREJUDICE IN REGARD TO IRREGULARITY OF BIDS.
- 2. Items classified on the bid schedule as "ALTERNATE ITEMS" and/or "ALTERNATE TYPES OF CONSTRUCTION" must be preselected and indicated on bids. However, "Alternate Types of Construction" may include Optional Items to be treated as set out in Paragraph 1, above.
- 3. Optional items not preselected and indicated on the bid schedule MUST be designated in accordance with Subsection 102.06 prior to or at the time of execution of the contract.
- 4. Optional and Alternate items designated must be used throughout the project.

I (We) further propose to perform all "force account or extra work" that may be required of me (us) on the basis provided in the Specifications and to give such work my (our) personal attention in order to see that it is economically performed.

I (We) further propose to execute the attached contract agreement (Section 902) as soon as the work is awarded to me (us), and to begin and complete the work within the time limit(s) provided for in the Specifications and Advertisement. I (We) also propose to execute the attached contract bond (Section 903) in an amount not less than one hundred (100) percent of the total of my (our) part, but also to guarantee the excellence of both workmanship and materials until the work is finally accepted.

Last Edited 6/12/2018

SECTION 905 - PROPOSAL (CONTINUED)

I (We) shall submit electronically with our proposal or deliver prior to the bid opening time a certified check, cashier's check or bid bond for <u>five percent (5%) of total bid</u> and hereby agree that in case of my (our) failure to execute the contract and furnish bond within Ten (10) days after notice of award, the amount of this check (bid bond) will be forfeited to the State of Mississippi as liquidated damages arising out of my (our) failure to execute the contract as proposed. It is understood that in case I am (we are) not awarded the work, the check will be returned as provided in the Specifications.

electronic submission via any authorized electrocertifications, disclosures and affidavits incorporate enforceable and binding upon delivery of the binot extend to the bid bond or alternate secution. This signature does not cure def I (We) also acknowledge the right of the disclosure or affidavit contained in the proposal	re below of a paper bid submission, or by digital signature of an onic submittal software, of the Section 905 proposal below, that all brated herein are deemed to be duly executed in the aggregate, fully id proposal. I (We) further acknowledge that this certification shall urity which must be separately executed for the benefit of the ficiencies in any required certifications, disclosures and/or affidavits.
Bidder acknowledges receipt of and has added t following addendum (addenda):	o and made a part of the proposal and contract documents the
ADDENDUM NO DATED	_ ADDENDUM NO DATED
ADDENDUM NO DATED	_ ADDENDUM NO DATED
Addendum No. 1 1. Replace Advertisement fob Bids with attached Advertisement for Bids	L ADDENDA: agree with total addenda issued prior to opening of bids) Respectfully submitted, DATE:
2. Replace SECTION 905 – PROPOSAL (CONTINUED) with attached SECTION 905-PROPOSAL (CONTINUED). (2 sheets)	Contractor BY:
Addendum No. 2	ADDRESS:
Replace Section 905-Proposal with attached section 905 Proposal	CITY:
Replace Section 905 Bid Proposal with attached section 905 Bid Proposal	PHONE:
3. Replace Wage Rates with attached Wage Rates.4. Replace sheets 3, 4, 5, 21, 23, 30	FAX: EMAIL:
thru 36, 38, 39, and 42 in the plans	

Bid Schedule

Project Number	STP-0210-00(044)LPA / 109418 - 701000
County	FORREST
Project Description	USM - Library Plaza and Forrest Avenue Pedestrian Plaza Phas

I (We) agree to complete the entire project within the specified contract time.

SPECIAL NOTICE TO BIDDERS

BIDS WILL NOT BE CONSIDERED UNLESS BOTH UNIT PRICES AND ITEM TOTALS ARE ENTERED.

BIDS WILL NOT BE CONSIDERED UNLESS THE BID CERTIFICATE LOCATED AT THE END OF THE BID SHEET IS SIGNED.

Line No.	Pay Item No.	Plan Quantity	Unit	Description	Unit Price	Item Total
10	202-A001	1	LS	Removal of Obstructions	XXXXX	
20	202-B007	340	SY	Removal of Asphalt Pavement, All Depths		
30	202-B073	1,040	SY	Removal of Concrete Pavement, All Depths		
40	202-B080	290	SY	Removal of Concrete Sidewalk		
50	202-B088	590	LF	Removal of Curb & Gutter, All Types		
60	202-B159	270	LF	Removal of Hand Rail		
70	202-B164	1	EA	Removal of Inlet and Junction Box, All Types & Sizes		
80	202-B178	11	EA	Removal of Low Mast Lighting Assembly and Foundation		
90	202-B204	60	LF	Removal of Retaining Wall		
100	202-B240	300	LF	Removal of Traffic Stripe		
110	202-B244	16	EA	Removal of Trees		
120	203-EX020	650	CY	Borrow Excavation, AH, FME, Class B9		
130	203-G001	650	CY	Excess Excavation, FM, AH		
140	211-C001	50	CY	Topsoil for Plant Holes, Contractor Furnished		
150	212-B001	550	SY	Standard Ground Preparation		
160	216-B002	550	SY	Solid Sodding, Centipede		
170	230-B015	2	EA	Tree Planting, Chaste Tree		
180	230-B082	2	EA	Tree Planting, Sweet Bay Magnolia		
190	230-D001	4,800	SF	Bed Preparation		
200	232-A002	1	K	Fertilizer for Woody Plant Material, Tablet, 10 gram		

210	232-A003	2	K	Fertilizer for Woody Plant Material, Tablet, 21 gram		
220	233-A003	50	CY	Tree Bark Mulch, Type III		
230	907-234-A001	925	LF	Temporary Silt Fence		
240	237-A001	40	LF	Wattles, 12"		
250	907-242-A001	1	LS	Construction of PAVER LOGO	XXXXX	
260	907-242-A002	215	LF	Installation of CONCRETE BAND, 24"		
270	907-242-A002	30	LF	Installation of ACCENT LIGHTS		
280	907-242-A002	85	LF	Installation of TRENCH DRAIN		
290	907-242-A002	55	LF	Installation of CONCRETE BAND, 12"		
300	907-242-A002	260	LF	Installation of CONCRETE BAND, 6"		
310	907-242-A003	1	EA	Installation of STRING LIGHT STRUCTURE, ADJACENT TO LIBRARY		
320	907-242-A003	28	EA	Installation of BISTRO TABLES & CHAIRS		
330	907-242-A003	7	EA	Installation of ROUND PICNIC TABLE		
340	907-242-A003	1	EA	Installation of FOCAL POINT SIGN		
350	907-242-A003	2	EA	Installation of STRING LIGHT STRUCTURE		
360	907-242-A003	1	EA	Installation of FOOD TRUCK PEDESTAL		
390	907-242-PP002	1	LS	Installation of ARTIFICIAL TURF, PER PLANS	XXXXX	
400	246-A002	40	EA	Sandbags		
410	907-258-E001	4	EA	Trash Receptacle		
420	907-258-J001	12	EA	Metal Bench		
430	907-258-K001	4	EA	Bollard REMOVABLE		
440	907-258-K001	7	EA	Bollard PERMANENET		
450	907-259-B001	7	EA	Lighting Assembly, Bollards		
460	907-259-F001	5	EA	Weatherproof GFCI Receptacle ON STRUCTURE		
470	907-282-B001	160	LF	Piping, 1 1/2" Diameter		
480	907-282-B003	1,955	LF	Piping, 1" Diameter		
490	907-282-B006	80	LF	Piping, 2" Diameter		
500	907-282-C003	350	LF	Sleeves, 4"		
510	907-282-D001	250	LF	Valve Control Wire		
520	907-282-G001	1	EA	Electric Controller, 12 Station		
530	907-282-H002	1	EA	Electric Control Valve, 1"		
540	907-282-H003	3	EA	Electric Control Valve, 2"		
550	907-282-H003	1	EA	Electric Control Valve, 2" HOT TAP, METER, MASTER VALVE, BACKFLOW & ENCLOSURE, & FLOW SENSOR		
560	907-282-J003	3	EA	Isolation Valve, 2"		

570	304-E003	30	CY	Granular Material, LVM, Crushed Stone CRUSHED GRANITE PAVING SURFACE		
580	304-G001	220	CY	Size 3/4" and Down Crushed Stone Base, AEA		
				OR		
590	304-G002	220	CY	Size 610 Crushed Stone Base, AEA		
				OR		
600	304-G003	220	CY	Size 825B Crushed Stone Base, AEA		
610	601-B001	6	CY	Class "B" Structural Concrete, Minor Structures DRAINAGE		
620	601-B001	30	CY	Class "B" Structural Concrete, Minor Structures RAMP		
630	601-B001	15	CY	Class "B" Structural Concrete, Minor Structures STAIRS		
640	602-A001	500	LBS	Reinforcing Steel RAMP		
650	602-A001	250	LBS	Reinforcing Steel STAIRS		
660	602-A001	300	LBS	Reinforcing Steel DRAINAGE		
670	603-PE001	235	LF	12" Corrugated Polyethylene Pipe PERFORATED WITH SOCK		
680	603-PE008	295	LF	6" Corrugated Polyethylene Pipe PERFORATED WITH SOCK		
690	604-B001	400	LBS	Gratings		
700	608-B001	700	SY	Concrete Sidewalk, With Reinforcement 4" THICKNESS		
710	608-B001	550	SY	Concrete Sidewalk, With Reinforcement		
720	907-608-C001	25	SF	Detectable Warning Panels		
730	609-A001	185	LF	Concrete Gutter, Special Design V GUTTER		
740	609-B002	120	LF	Concrete Curb, Header		
750	609-D004	15	LF	Combination Concrete Curb and Gutter Type 2 Modified		
760	907-611-B001	4,650	SF	Brick Pavers		
770	613-D009	12	EA	Adjustment of Utility Appurtenance		
780	907-618-A001	1	LS	Maintenance of Traffic	XXXXX	
790	618-B001	1	SF	Additional Construction Signs	10.00	\$10.00
800	620-A001	1	LS	Mobilization	XXXXX	
810	907-626-G003	285	LF	Thermoplastic Detail Stripe, Blue-ADA		
820	907-626-H008	210	SF	Thermoplastic Legend, Blue-ADA		
830	907-637-C009	590	LF	Traffic Signal Conduit, Underground, Rolled Pipe, 2"		
840	682-A006	350	LF	Underground Branch Circuit, AWG 1/0, 4 Conductor		
850	682-A010	540	LF	Underground Branch Circuit, AWG 10, 3 Conductor		

860	682-A012	740	LF	Underground Branch Circuit, AWG 10, 5 Conductor		
870	682-A039	835	LF	Underground Branch Circuit, AWG 8, 3 Conductor		
880	682-A041	1,800	LF	Underground Branch Circuit, AWG 8, 5 Conductor		
890	907-682-A1009	100	LF	Branch Circuit Wire, AWG #10, 3 Conductor		
900	682-D003	2	EA	Underground Pull Box		
910	682-F001	1	EA	Secondary Power Controller		
920	907-683-PP001	3	EA	Lighting Assembly, Per Plans UPLIGHTS		
930	907-683-PP001	4	EA	Lighting Assembly, Per Plans SIGN LIGHT		
940	684-A003	2	CY	Pole Foundation, 24" Diameter		
950	684-A004	25	CY	Pole Foundation, 30" Diameter		
960	699-A001	1	LS	Roadway Construction Stakes	XXXXX	
970	L00011 - 230-B500	4	EA	Tree Planting, LACEBARK ELM		
980	L00011 - 230-B500	6	EA	Tree Planting, SOUTHERN LIVE OAK		
990	L00016 - 683-B500	11	EA	Lighting Assembly, Low Mast,		
1000	L00018 - 907-258-PP502	285	LF	Handrail, Per Plans Ramp		
1010	L00018 - 907-258-PP502	65	LF	Handrail, Per Plans Stair		
1020	L00064 - 202-B504	4	EA	Removal of Bollard		
1030	L00070 - 907-233-C500	950	SY	Pine Straw Mulch		
1040	L00076 - 230-A500	43	EA	Shrub Planting, 'DESERT PLAINS PRAIRIE WINDS' FOUNTAIN GRASS		
1050	L00076 - 230-A500	14	EA	Shrub Planting, 'AUTUMN LILY' ENCORE AZALEA		
1060	L00076 - 230-A500	29	EA	Shrub Planting, 'LIMELIGHT' HYDRANGEA		
1070	L00076 - 230-A500	23	EA	Shrub Planting, 'OCTOBER MAGIC' SHI-SHI CAMELLIA		
1080	L00076 - 230-A500	12	EA	Shrub Planting, 'PURPLE DAYDREAM' LOROPETALUM		
1090	L00076 - 230-A500	4	EA	Shrub Planting, SWEET OLIVE		
1100	L00076 - 230-A500	57	EA	Shrub Planting, 'BLUE CASCADE' DISTYLIUM		
1110	L00076 - 230-A500	114	EA	Shrub Planting, VARIEGATED SHELL GINGER		
1120	L00076 - 230-A500	194	EA	Shrub Planting, LOUISIANNA IRIS		
1130	L00076 - 230-A500	101	EA	Shrub Planting, 'GOLDSTRUM' CONEFLOWER		
1140	L00076 - 230-A500	642	EA	Shrub Planting, MONDO GRASS		
1150	L00076 - 230-A500	151	EA	Shrub Planting, 'NEW GOLD' LANTANA		
1160	L00076 - 230-A500	162	EA	Shrub Planting, 'ASIATIC JASMINE'		
1170	L00077 - 907-603-PP003	8	EA	Preformed Polyethylene Drainage Catch Basin 24"		
1180	L00083 - 907-258-PP508	260	LF	Seat Wall, Per Plans		
1190	L00088 - 907-202-PP500	1	LS	Removal of, Per Plans EXISTING LANDSCAPE	XXXXX	

1200	L00099 - 620-B500	1	DAY	Requisite Work, HYDRO-EXCAVATION		
1210	L00102 - 202-B506	320	SF	Removal of CONCRETE STAIRS		
1220	L00102 - 202-B506	10,080	SF	Removal of PAVERS		
1230	L00103 - 907-282-A500	176	EA	Sprinkler Head, SPRAY HEAD, Turf or Bed		
1240	L00103 - 907-282-A500	10	EA	Sprinkler Head, ROTOR HEAD, Turf		
	Total Bid Amount					

	Add Option No. 1					
Line No. Pay Item No. Plan Quantity Unit Description Unit Price Item Total						
370	907-242-A006	1	EA	Construction of SHADE STRUCTURE 1		
	Total Add Option No. 1 Amount					

	Add Option No. 2						
Line No.	Pay Item No.	Plan Quantity	Unit	Description	Unit Price	Item Total	
380	907-242-A006	1	EA	Construction of SHADE STRUCTURE 2			
					Total Add Option No. 2 Amo	unt	

Total Base Bid	\$
Total Add Option No. 1	\$
Total Add Option No. 2	\$
Total Bid	\$

1. I/We agree that no less than percent shall be expended with small business concerns owned and controlled by socially and economically disadvantaged individuals (DBE and WBE).								
2. Classification of Bidder: Small Business (DBE) Small Business(WBE)								
3. A joint venture with a Small Business (DBE/WBE): YES								
*** SIGNATURE STATEMENT *** BIDDER ACKNOWLEDGES THAT HE/SHE HAS CHECKED ALL ITEMS IN THIS PROPOSAL FOR ACCURACY AND CERTIFY THAT THE FIGURES SHOWN THEREIN CONSTITUTE THEIR OFFICIAL BID.								
BIDDER'S SIGNATURE								

"General Decision Number: MS20250131 09/19/2025

Superseded General Decision Number: MS20240131

State: Mississippi

Construction Type: Highway

County: Forrest County in Mississippi.

HIGHWAY CONSTRUCTION PROJECTS

Note: Contracts subject to the Davis-Bacon Act are generally required to pay at least the applicable minimum wage rate required under Executive Order 14026 or Executive Order 13658. Please note that these Executive Orders apply to covered contracts entered into by the federal government that are subject to the Davis-Bacon Act itself, but do not apply to contracts subject only to the Davis-Bacon Related Acts, including those set forth at 29 CFR 5.1(a)(1).

If the contract is entered into on or after January 30, 2022, or the contract is renewed or extended (e.g., an |. The contractor must pay option is exercised) on or after January 30, 2022:

- . Executive Order 14026 generally applies to the contract.
- all covered workers at least \$17.75 per hour (or the applicable wage rate listed on this wage determination, if it is higher) for all hours spent performing on the contract in 2025.

If the contract was awarded on . or between January 1, 2015 and January 29, 2022, and the contract is not renewed or extended on or after January 30, 2022:

- Executive Order 13658 generally applies to the contract.
- |. The contractor must pay all| covered workers at least \$13.30 per hour (or the applicable wage rate listed on this wage determination, if it is higher) for all hours spent performing on that contract in 2025.

The applicable Executive Order minimum wage rate will be adjusted annually. If this contract is covered by one of the Executive Orders and a classification considered necessary for performance of work on the contract does not appear on this wage determination, the contractor must still submit a conformance request.

Additional information on contractor requirements and worker protections under the Executive Orders is available at http://www.dol.gov/whd/govcontracts.

Modification Number Publication Date

0 01/03/2025 1 09/19/2025

^{*} ELEC0903-006 06/01/2025

	Rates	Fringes
ELECTRICIAN	.\$ 32.15	7.76+9.75%
* SUMS2010-054 08/04/2014		
	Rates	Fringes
CARPENTER (Form Work Only)	.\$ 12.00 **	0.00
CEMENT MASON/CONCRETE FINISHER	.\$ 11.54 **	1.63
HIGHWAY/PARKING LOT STRIPING:		
Truck Driver (Line Striping Truck)	.\$ 14.55 **	0.00
INSTALLER - SIGN	.\$ 12.19 **	0.00
INSTALLER: Guardrail	.\$ 12.39 **	0.00
IRONWORKER, REINFORCING	.\$ 16.44 **	0.00
LABORER: Common or General,		
<pre>Including Asphalt Raking, Shoveling, Spreading</pre>	.\$ 10.34 **	0.00
LABORER: Flagger	.\$ 11.42 **	0.00
LABORER: Grade Checker	.\$ 14.82 **	0.00
LABORER: Luteman	.\$ 12.88 **	0.00
LABORER: Mason Tender - Cement/Concrete	.\$ 10.57 **	0.00

LABORER: F	Pipelayer\$	14.50	**	0.00
Barricades	aborer-Cones/ /Barrels - er/Sweeper\$	12.17	**	0.00
	Asphalt Spreader\$			0.00
OPERATOR: Backhoe/Exc	cavator/Trackhoe\$	14.20	**	0.00
	Bobcat/Skid Loader\$	11.86	**	0.00
OPERATOR:	Broom/Sweeper\$	10.94	**	0.00
OPERATOR:	Bulldozer\$	13.99	**	0.00
OPERATOR:	Concrete Saw\$	13.93	**	0.00
OPERATOR:	Crane\$	14.80	**	0.00
OPERATOR:	Distributor\$	11.46	**	0.00
OPERATOR:	Grader/Blade\$	16.09	**	0.00
OPERATOR:	Loader\$	13.99	**	0.00
OPERATOR:	Mechanic\$	13.00	**	0.00
OPERATOR:	Milling Machine\$	16.96	**	0.00
OPERATOR:	Oiler\$	12.22	**	0.00
	Paver (Asphalt, and Concrete)\$	11.56	**	0.00
OPERATOR:	Roller (All Types)\$	12.17	**	0.00
OPERATOR:	Scraper\$	14.00	**	0.00
OPERATOR:	Tractor\$	12.00	**	0.00
•	Staking, Marking Clearing)\$	11.56	**	0.00
TRUCK DRIVE	ER: Flatbed Truck\$	14.72	**	0.00
TRUCK DRIVE	ER: Lowboy Truck\$	14.18	**	0.00

TRUCK DRIVER:	Mechanic\$	12.31	**	0.00
TRUCK DRIVER:	Water Truck\$	17.08	**	0.00
	Dump Truck (All \$	11.58	**	0.00
TRUCK DRIVER:	Semi/Trailer \$	14.36	**	0.00

WELDERS - Receive rate prescribed for craft performing operation to which welding is incidental.

** Workers in this classification may be entitled to a higher minimum wage under Executive Order 14026 (\$17.75) or 13658 (\$13.30). Please see the Note at the top of the wage determination for more information. Please also note that the minimum wage requirements of Executive Order 14026 are not currently being enforced as to any contract or subcontract to which the states of Texas, Louisiana, or Mississippi, including their agencies, are a party.

Note: Executive Order (EO) 13706, Establishing Paid Sick Leave for Federal Contractors applies to all contracts subject to the Davis-Bacon Act for which the contract is awarded (and any solicitation was issued) on or after January 1, 2017. If this contract is covered by the EO, the contractor must provide employees with 1 hour of paid sick leave for every 30 hours they work, up to 56 hours of paid sick leave each year. Employees must be permitted to use paid sick leave for their own illness, injury or other health-related needs, including preventive care; to assist a family member (or person who is like family to the employee) who is ill, injured, or has other health-related needs, including preventive care; or for reasons resulting from, or to assist a family member (or person who is like family to the employee) who is a victim of, domestic violence, sexual assault, or stalking. Additional information on contractor requirements and worker protections under the EO is available at

https://www.dol.gov/agencies/whd/government-contracts.

Unlisted classifications needed for work not included within the scope of the classifications listed may be added after award only as provided in the labor standards contract clauses (29CFR 5.5 (a) (1) (iii)).

The body of each wage determination lists the classifications and wage rates that have been found to be prevailing for the type(s) of construction and geographic area covered by the wage determination. The classifications are listed in alphabetical order under rate identifiers indicating whether the particular rate is a union rate (current union negotiated rate), a survey rate, a weighted union average rate, a state adopted rate, or a supplemental classification rate.

Union Rate Identifiers

A four-letter identifier beginning with characters other than ""SU"", ""UAVG"", ?SA?, or ?SC? denotes that a union rate was prevailing for that classification in the survey. Example: PLUM0198-005 07/01/2024. PLUM is an identifier of the union whose collectively bargained rate prevailed in the survey for this classification, which in this example would be Plumbers. 0198 indicates the local union number or district council number where applicable, i.e., Plumbers Local 0198. The next number, 005 in the example, is an internal number used in processing the wage determination. The date, 07/01/2024 in the example, is the effective date of the most current negotiated rate.

Union prevailing wage rates are updated to reflect all changes over time that are reported to WHD in the rates in the collective bargaining agreement (CBA) governing the classification.

Union Average Rate Identifiers

The UAVG identifier indicates that no single rate prevailed for those classifications, but that 100% of the data reported for the classifications reflected union rates. EXAMPLE: UAVG-OH-0010 01/01/2024. UAVG indicates that the rate is a weighted union average rate. OH indicates the State of Ohio. The next number, 0010 in the example, is an internal number used in producing the wage determination. The date, 01/01/2024 in the example, indicates the date the wage determination was updated to reflect the most current union average rate.

A UAVG rate will be updated once a year, usually in January, to reflect a weighted average of the current rates in the collective bargaining agreements on which the rate is based.

Survey Rate Identifiers

The ""SU"" identifier indicates that either a single non-union rate prevailed (as defined in 29 CFR 1.2) for this classification in the survey or that the rate was derived by computing a weighted average rate based on all the rates reported in the survey for that classification. As a weighted average rate includes all rates reported in the survey, it may include both union and non-union rates. Example: SUFL2022-007 6/27/2024. SU indicates the rate is a single non-union prevailing rate or a weighted average of survey data for that classification. FL indicates the State of Florida. 2022 is the year of the survey on which these classifications and rates are based. The next number, 007 in the example, is an internal number used in producing the wage determination. The date, 6/27/2024 in the example, indicates the survey completion date for the classifications and rates under that identifier.

?SU? wage rates typically remain in effect until a new survey is conducted. However, the Wage and Hour Division (WHD) has the discretion to update such rates under 29 CFR 1.6(c)(1).

State Adopted Rate Identifiers

The ""SA"" identifier indicates that the classifications and prevailing wage rates set by a state (or local) government were adopted under 29 C.F.R 1.3(g)-(h). Example: SAME2023-007 01/03/2024. SA reflects that the rates are state adopted. ME refers to the State of Maine. 2023 is the year during which the state completed the survey on which the listed classifications and rates are based. The next number, 007 in the example, is an internal number used in producing the wage determination. The date, 01/03/2024 in the example, reflects the date on which the classifications and rates under the ?SA? identifier took effect under state law in the state from which the rates were adopted.

WAGE DETERMINATION APPEALS PROCESS

- 1) Has there been an initial decision in the matter? This can be:
 - a) a survey underlying a wage determination
 - b) an existing published wage determination
- c) an initial WHD letter setting forth a position on a wage determination matter
- d) an initial conformance (additional classification and rate) determination

On survey related matters, initial contact, including requests

for summaries of surveys, should be directed to the WHD Branch of Wage Surveys. Requests can be submitted via email to davisbaconinfo@dol.gov or by mail to:

Branch of Wage Surveys Wage and Hour Division U.S. Department of Labor 200 Constitution Avenue, N.W. Washington, DC 20210

Regarding any other wage determination matter such as conformance decisions, requests for initial decisions should be directed to the WHD Branch of Construction Wage Determinations. Requests can be submitted via email to BCWD-Office@dol.gov or by mail to:

Branch of Construction Wage Determinations Wage and Hour Division U.S. Department of Labor 200 Constitution Avenue, N.W. Washington, DC 20210

2) If an initial decision has been issued, then any interested party (those affected by the action) that disagrees with the decision can request review and reconsideration from the Wage and Hour Administrator (See 29 CFR Part 1.8 and 29 CFR Part 7). Requests for review and reconsideration can be submitted via email to dba.reconsideration@dol.gov or by mail to:

Wage and Hour Administrator U.S. Department of Labor 200 Constitution Avenue, N.W. Washington, DC 20210

The request should be accompanied by a full statement of the interested party's position and any information (wage payment data, project description, area practice material, etc.) that the requestor considers relevant to the issue.

3) If the decision of the Administrator is not favorable, an interested party may appeal directly to the Administrative Review Board (formerly the Wage Appeals Board). Write to:

Administrative Review Board U.S. Department of Labor 200 Constitution Avenue, N.W. Washington, DC 20210.


ADDENDUM

	SUMMARY OF QUANTITIES (SHEET 1)							
PAY ITEM NO.	PAY ITEM	UNIT	FORREST : 10941	18-701000 Final				
202-A001	Removal of Obstructions	LS	1	I IIIai				
202-B007	Removal of Asphalt Pavement, All Depths	SY	340					
202-B077 202-B073	Removal of Concrete Pavement, All Depths	SY	1,040					
202-B075 202-B080	Removal of Concrete Sidewalk	SY	290					
202-B088	Removal of Curb & Gutter, All Types	LF	590					
202-B000 202-B159	Removal of Hand Rail	LF	270					
202-B153 202-B164	Removal of Inlet and Junction Box, All Types & Sizes	EA	1					
202-B101 202-B178	Removal of Low Mast Lighting Assembly and Foundation	EA	11					
202-B170 202-B204	Removal of Retaining Wall	LF	60					
202-B240	Removal of Traffic Stripe	LF	300					
202-B244	Removal of Trees	EA	16					
203-EX020	Borrow Excavation, AH, FME, Class B9	CY	650					
203-G001	Excess Excavation, FM, AH	CY	650					
211-C001	Topsoil for Plant Holes, Contractor Furnished	CY	50					
211-C001 212-B001	Standard Ground Preparation	SY	550					
216-B002	Solid Sodding, Centipede	SY	550					
230-B015	Tree Planting, Chaste Tree	EA	2					
230-B013	Tree Planting, Chaste Tree Tree Planting, Sweet Bay Magnolia	EA	2					
230-D002	Bed Preparation	SF	4,800					
.30-D001 .32-A002	Fertilizer for Woody Plant Material, Tablet, 10 gram	K	1					
232-A002	Fertilizer for Woody Flant Material, Tablet, 10 gram Fertilizer for Woody Plant Material, Tablet, 21 gram	K	2					
233-A003	Tree Bark Mulch, Type III	CY	50					
07-234-A001	Temporary Silt Fence	LF	925					
237-A001 237-A001	Wattles, 12"	LF	40					
907-242-A001	Construction of PAVER LOGO	LS	1					
007-242-A001 007-242-A002	Installation of TRENCH DRAIN	LF	85					
907-242-A002	Installation of CONCRETE BAND, 12"	LF	55					
907-242-A002	Installation of CONCRETE BAND, 6"	LF	260					
907-242-A002	Installation of CONCRETE BAND, 24"	LF	215					
907-242-A002	Installation of ACCENT LIGHTS	LF	30					
907-242-A003	Installation of ACCENT LIGHTS Installation of STRING LIGHT STRUCTURE, ADJACENT TO LIBRARY	EA	1					
907-242-A003	Installation of BISTRO TABLES & CHAIRS	EA	28					
907-242-A003	Installation of ROUND PICNIC TABLE	EA	7					
907-242-A003	Installation of FOCAL POINT SIGN	EA	1					
907-242-A003	Installation of STRING LIGHT STRUCTURE	EA	2					
907-242-A003	Installation of FOOD TRUCK PEDESTAL	EA	1					
907-242-PP002	Installation of ARTIFICIAL TURF, PER PLANS	LS	1					
246-A002	Sandbags	EA	40					
907-258-E001	Trash Receptacle	EA	4					
907-258-L001 907-258-J001	Metal Bench	EA	12					
907-258-K001	Bollard REMOVABLE	EA	12					
907-258-K001 907-258-K001	Bollard PERMANENET	EA	7					
907-250-R001 907-259-B001	Lighting Assembly, Bollards	EA	7					
907-259-6001 907-259-F001	Weatherproof GFCI Receptacle ON STRUCTURE	EA	/ 					

FMS: 109418-701000

STATE	PROJECT NO.
MISS	STP-0210-00(044)LPA

- 1 INCLUDES 2 CONCRETE PLANTERS, 2 CONCRETE HANDRAILS
- ② INCLUDES SAW CUTTING
- ③ VARIABLE HEIGHT. INCLUDES FOUNDATION
- 4 LIGHTING ASSEMBLIES TO BE REMOVED WITH CARE AND SALVAGED TO THE UNIVERSITY

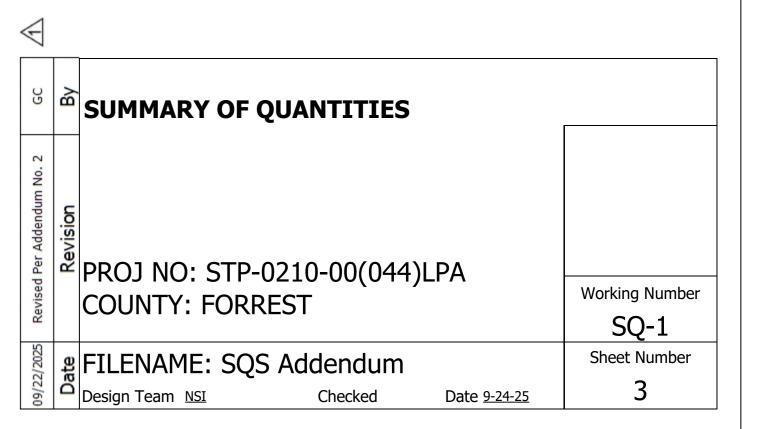

FMS: 109418-701000

STATE	PROJECT NO.
MISS	STP-0210-00(044)LPA

PAY ITEM NO.	PAY ITEM	UNIT	FORREST : 109418-70100
PATTILM NO.	FAI IILM	OINTI	Prelim Final
907-282-B001	Piping, 1 1/2" Diameter	LF	160
907-282-B003	Piping, 1" Diameter	LF	1,955
907-282-B006	Piping, 2" Diameter	LF	80
907-282-C003	Sleeves, 4"	LF	350
907-282-D001	Valve Control Wire	LF	250
907-282-G001	Electric Controller, 12 Station	EA	1
907-282-H002	Electric Control Valve, 1"	EA	1
907-282-H003	Electric Control Valve, 2"	EA	3
907-282-H003	Electric Control Valve, 2" HOT TAP, METER, MASTER VALVE, BACKFLOW & ENCLOSURE, & FLOW SENSOR	EA	1
907-282-J003	Isolation Valve, 2"	EA	3
304-E003	Granular Material, LVM, Crushed Stone CRUSHED GRANITE PAVING SURFACE	CY	30
304-G001	Size 3/4" and Down Crushed Stone Base, AEA OR	CY	220
204 C002		CY	220
304-G002	Size 610 Crushed Stone Base, AEA	Ci	220
204 C002	OR Size 92FB Crushed Stone Base AFA	CY	220
304-G003	Size 825B Crushed Stone Base, AEA	CY	220
601-B001	Class "B" Structural Concrete, Minor Structures DRAINAGE	CY	20
601-B001	Class "B" Structural Concrete, Minor Structures RAMP	CY	30
601-B001	Class "B" Structural Concrete, Minor Structures STAIRS	LBS	15
602-A001	Reinforcing Steel RAMP	LBS	500
602-A001	Reinforcing Steel STAIRS Reinforcing Steel DRAINAGE	LBS	250
602-A001	Reinforcing Steel DRAINAGE 12" Corrugated Polyothylana Dina DEDEODATED WITH SOCK	LF	300
603-PE001	12" Corrugated Polyethylene Pipe PERFORATED WITH SOCK	LF	235 295
603-PE008 604-B001	6" Corrugated Polyethylene Pipe PERFORATED WITH SOCK	LBS	400
608-B001	Gratings Concrete Sidowalk, With Beinforcement 4" THICKNESS	SY	700
608-B001	Concrete Sidewalk, With Reinforcement 4" THICKNESS Concrete Sidewalk, With Reinforcement	SY	
907-608-C001		SF	550
	Detectable Warning Panels Concrete Cutter, Special Design V CUTTER	LF	25
609-A001 609-B002	Concrete Gutter, Special Design V GUTTER Concrete Curb, Header	LF	185
609-6002 609-D004	Combination Concrete Curb and Gutter Type 2 Modified	LF	120
907-611-B001	Brick Pavers	SF	4,650
613-D009	Adjustment of Utility Appurtenance	EA	12
907-618-A001	Maintenance of Traffic	LS	12
618-B001	Additional Construction Signs	SF	1
620-A001	Mobilization	LS	1
907-626-G003	Thermoplastic Detail Stripe, Blue-ADA	LF	285
907-626-G003 907-626-H008	Thermoplastic Detail Stripe, Blue-ADA Thermoplastic Legend, Blue-ADA	SF	210
907-620-11008 907-637-C009	Traffic Signal Conduit, Underground, Rolled Pipe, 2"	LF	590
682-A006	Underground Branch Circuit, AWG 1/0, 4 Conductor	LF	350
682-A000 682-A010	Underground Branch Circuit, AWG 1/0, 4 Conductor	LF	540
682-A010 682-A012	Underground Branch Circuit, AWG 10, 5 Conductor	LF	740
682-A012 682-A039	Underground Branch Circuit, AWG 10, 5 Conductor	LF	835
682-A039 682-A041	Underground Branch Circuit, AWG 8, 5 Conductor Underground Branch Circuit, AWG 8, 5 Conductor	LF	1,800

ADDENDUM

\exists			
CC	By	SUMMARY OF QUANTITIES	
Revised Per Addendum No. 2		PROJ NO: STP-0210-00(044)LPA COUNTY: FORREST	Working Number SQ-2
09/22/2025	ate	FILENAME: SQS Addendum Design Team, NSI Checked Date 9-24-25	Sheet Number
09/22	Ö	Design Team NSI Checked Date 9-24-25	4


ADDENDUM


	SUMMARY OF QUANTITIES (SHEET 3)		
PAY ITEM NO.	PAY ITEM	UNIT	FORREST: 109418-701000 Prelim Final	
907-682-A1009	Branch Circuit Wire, AWG #10, 3 Conductor	LF	100	
682-D003	Underground Pull Box	EA	2	
682-F001	Secondary Power Controller	EA	1	(
907-683-PP001	Lighting Assembly, Per Plans UPLIGHTS	EA	3	_
907-683-PP001	Lighting Assembly, Per Plans SIGN LIGHT	EA	4	_
684-A003	Pole Foundation, 24" Diameter	CY	2	_
684-A004	Pole Foundation, 30" Diameter	CY	25	_
699-A001	Roadway Construction Stakes	LS	1	
L00011: 230-B500	Tree Planting, LACEBARK ELM	EA	4	
L00011: 230-B500	Tree Planting, SOUTHERN LIVE OAK	EA	6	
L00016: 683-B500	Lighting Assembly, Low Mast,	EA	11	
L00018: 907-258-PP50	Handrail, Per Plans Ramp	LF	285	
L00018: 907-258-PP50	Handrail, Per Plans Stair	LF	65	
L00064: 202-B504	Removal of Bollard	EA	4	
L00070: 907-233-C500	Pine Straw Mulch	SY	950	
L00076: 230-A500	Shrub Planting, 'DESERT PLAINS PRAIRIE WINDS' FOUNTAIN GRASS	EA	43	
L00076: 230-A500	Shrub Planting, 'AUTUMN LILY' ENCORE AZALEA	EA	14	
L00076: 230-A500	Shrub Planting, 'LIMELIGHT' HYDRANGEA	EA	29	
L00076: 230-A500	Shrub Planting, 'OCTOBER MAGIC' SHI-SHI CAMELLIA	EA	23	
L00076: 230-A500	Shrub Planting, 'PURPLE DAYDREAM' LOROPETALUM	EA	12	
L00076: 230-A500	Shrub Planting, SWEET OLIVE	EA	4	
L00076: 230-A500	Shrub Planting, 'BLUE CASCADE' DISTYLIUM	EA	57	
L00076: 230-A500	Shrub Planting, VARIEGATED SHELL GINGER	EA	114	
L00076: 230-A500	Shrub Planting, LOUISIANNA IRIS	EA	194	
L00076: 230-A500	Shrub Planting, 'GOLDSTRUM' CONEFLOWER	EA	101	
L00076: 230-A500	Shrub Planting, MONDO GRASS	EA	642	
L00076: 230-A500	Shrub Planting, 'NEW GOLD' LANTANA	EA	151	
L00076: 230-A500	Shrub Planting, 'ASIATIC JASMINE'	EA	162	
L00077: 907-603-PP00	Preformed Polyethylene Drainage Catch Basin 24"	EA	8	
L00083: 907-258-PP50	Seat Wall, Per Plans	LF	260	
L00088: 907-202-PP50	Removal of, Per Plans EXISTING LANDSCAPE	LS	1	
L00099: 620-B500	Requisite Work, HYDRO-EXCAVATION	DAY	1	
L00102: 202-B506	Removal of CONCRETE STAIRS	SF	320	(
L00102: 202-B506	Removal of PAVERS	SF	10,080	
L00103: 907-282-A500	Sprinkler Head, SPRAY HEAD, Turf or Bed	EA	176	
L00103: 907-282-A500	Sprinkler Head, ROTOR HEAD, Turf	EA	10	
	Add Option 1			
907-242-A006	Construction of SHADE STRUCTURE 1	EA	1	
	Add Option 2			
907-242-A006	Construction of SHADE STRUCTURE 2	EA	1	

FMS: 109418-701000

STATE	PROJECT NO.
MISS	STP-0210-00(044)LPA

- 1 INCLUDES SAW CUTTING
- 1 INCLUDES ALL THE WORK AND COMPONENTS IN THE ELECTRICAL ROOM ALONG WITH ANY CORE DRILL REQUIRED TO INSTALL THE CONDUITS TO THE ROOM

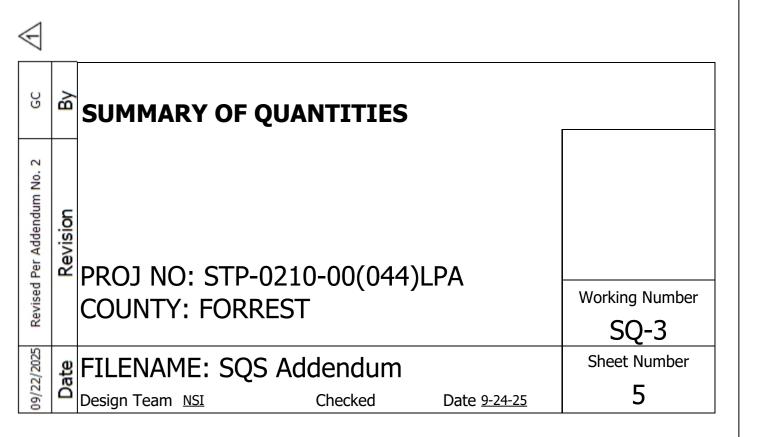


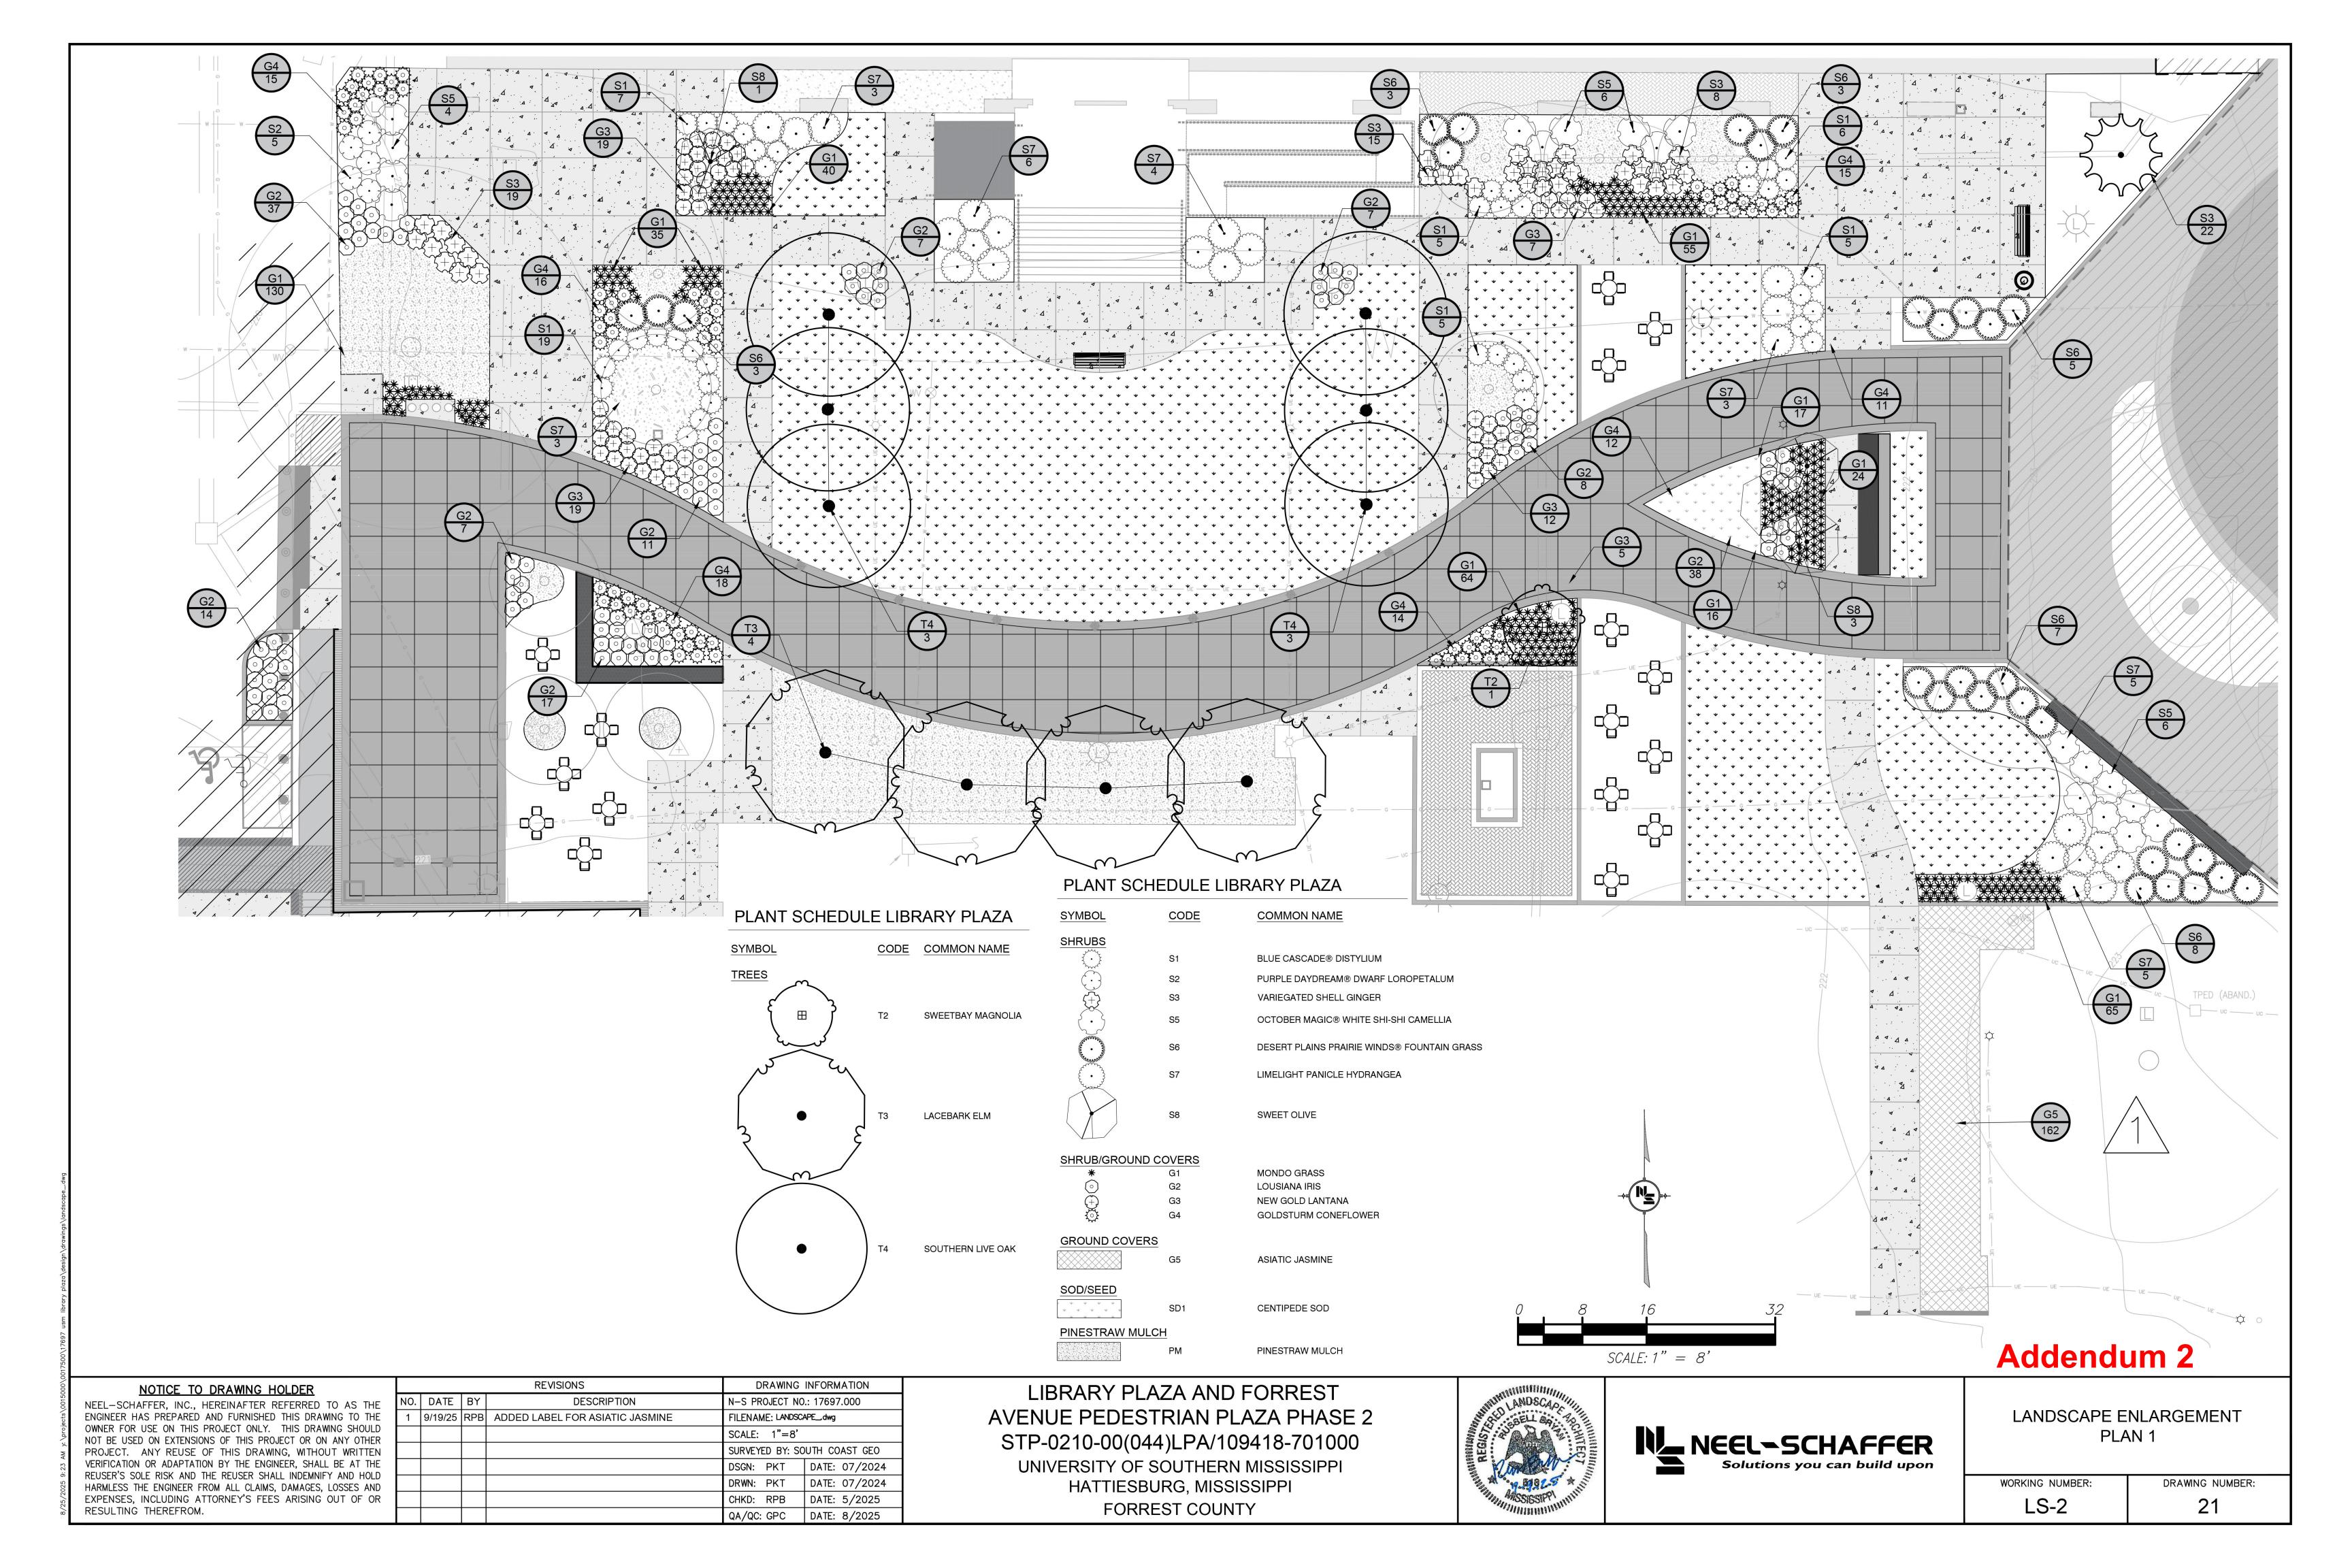

PLANT	PLANT SCHEDULE							
SYMBOL	CODE	COMMON / BOTANICAL NAME	QTY	SIZE/UNIT	RATES	REQUIREMENTS	NOTES	REMARKS
TREEŞ								
	T1	CHASTE TREE VITEX AGNUS-CASTUS	2	15 GAL.	EACH	MULTI-TRUNK/TREE FORM	FULL & HEALTHY PLANT	SEASONAL APPLICATION DATES BY REQUEST ONLY FALL & WINTER: OCTOBER 1 – APRIL 30
B	T2	SWEETBAY MAGNOLIA MAGNOLIA VIRGINIANA	2	30 GAL.	EACH	MULTI-TRUNK/TREE FORM	FULL & HEALTHY PLANT	SEASONAL APPLICATION DATES SPRING & SUMMER: MARCH 1 – SEPTEMBER 30 FALL & WINTER: OCTOBER 1 – APRIL 30
A TOTAL MANAGEMENT OF THE PROPERTY OF THE PROP	ТЗ	LACEBARK ELM ULMUS PARVIFOLIA	4	30 GAL.	EACH	SINGLE STRAIGHT TRUNK/TREE FORM; FULL CANOPY	FULL & HEALTHY PLANT	SEASONAL APPLICATION DATES SPRING & SUMMER: MARCH 1 – SEPTEMBER 30 FALL & WINTER: OCTOBER 1 – APRIL 30
\bigcirc	T4	SOUTHERN LIVE OAK QUERCUS VIRGINIANA	6	30 GAL.	EACH	SINGLE STRAIGHT TRUNK/TREE FORM; FULL CANOPY	FULL & HEALTHY PLANT	SEASONAL APPLICATION DATES SPRING & SUMMER: MARCH 1 – SEPTEMBER 30 FALL & WINTER: OCTOBER 1 – APRIL 30
SYMBOL	CODE	COMMON / BOTANICAL NAME	QTY	SIZE	RATES	REQUIREMENTS	NOTES	REMARKS
SHRUBS								
,	S1	BLUE CASCADE® DISTYLIUM DISTYLIUM X 'PIIDIST-II'	57	3 GAL.	EACH	NOT APPLICABLE	FULL & HEALTHY PLANT	SEASONAL APPLICATION DATES SPRING & SUMMER: MAY 1 – SEPTEMBER 30 NOT ALLOWED FALL & WINTER: OCTOBER 1 – APRIL 30
	S2	PURPLE DAYDREAM® DWARF LOROPETALUM LOROPETALUM CHINENSE RUBRUM 'PIILC-III'	12	3 GAL.	EACH	NOT APPLICABLE	FULL & HEALTHY PLANT	SEASONAL APPLICATION DATES SPRING & SUMMER: MAY 1 – SEPTEMBER 30 NOT ALLOWED FALL & WINTER: OCTOBER 1 – APRIL 30
\(+ \)	S3	VARIEGATED SHELL GINGER ALPINIA ZERUMBET 'VARIEGATA'	109	3 GAL.	EACH	NOT APPLICABLE	FULL & HEALTHY PLANT	SEASONAL APPLICATION DATES SPRING & SUMMER: MARCH 1 – SEPTEMBER 30 FALL & WINTER: OCTOBER 1 – APRIL 30
**************************************	S4	AUTUMN LILY® ENCORE® AZALEA AZALEA X 'ROBLEX'	14	3 GAL.	EACH	NOT APPLICABLE	FULL & HEALTHY PLANT	SEASONAL APPLICATION DATES SPRING & SUMMER: MAY 1 – SEPTEMBER 30 NOT ALLOWED FALL & WINTER: OCTOBER 1 – APRIL 30
	S 5	OCTOBER MAGIC® WHITE SHI-SHI CAMELLIA CAMELLIA SASANQUA 'GREEN 02-004'	23	3 GAL.	EACH	NOT APPLICABLE	FULL & HEALTHY PLANT	SEASONAL APPLICATION DATES SPRING & SUMMER: MAY 1 – SEPTEMBER 30 NOT ALLOWED FALL & WINTER: OCTOBER 1 – APRIL 30
MANANANANANANANANANANANANANANANANANANAN	S6	DESERT PLAINS PRAIRIE WINDS® FOUNTAIN GRASS PENNISETUM ALOPECUROIDES 'DESERT PLAINS'	43	3 GAL.	EACH	NOT APPLICABLE	FULL & HEALTHY PLANT	SEASONAL APPLICATION DATES SPRING & SUMMER: MARCH 1 – SEPTEMBER 30 FALL & WINTER: OCTOBER 1 – APRIL 30
£ • 33	S 7	LIMELIGHT PANICLE HYDRANGEA HYDRANGEA PANICULATA 'LIMELIGHT'	29	3 GAL.	EACH	NOT APPLICABLE	FULL & HEALTHY PLANT	SEASONAL APPLICATION DATES SPRING & SUMMER: MAY 1 – SEPTEMBER 30 NOT ALLOWED FALL & WINTER: OCTOBER 1 – APRIL 30
	S8	SWEET OLIVE OSMANTHUS FRAGRANS	4	3 GAL.	EACH	NOT APPLICABLE	FULL & HEALTHY PLANT	SEASONAL APPLICATION DATES SPRING & SUMMER: MAY 1 – SEPTEMBER 30 NOT ALLOWED FALL & WINTER: OCTOBER 1 – APRIL 30
SHRUB/GF	SULIND C	COVERS						
*	G1	MONDO GRASS OPHIOPOGON JAPONICUS	642	4" CONT.	EACH	12" SPACING	FULL & HEALTHY PLANT	SEASONAL APPLICATION DATES SPRING & SUMMER: MAY 1 – SEPTEMBER 30 NOT ALLOWED FALL & WINTER: OCTOBER 1 – APRIL 30
\bigcirc	G2	LOUSIANA IRIS IRIS GIGANTICAERULEA	194	1 GAL.	EACH	24" SPACING	FULL & HEALTHY PLANT	SPRING & SUMMER: MARCH 1 – SEPTEMBER 30 / FALL & WINTER: OCTOBER 1 – APRIL 30
+	G3	NEW GOLD LANTANA LANTANA X 'NEW GOLD'	151	1 GAL.	EACH	18" SPACING	FULL & HEALTHY PLANT	SEASONAL APPLICATION DATES SPRING & SUMMER: MAY 1 – SEPTEMBER 30 NOT ALLOWED FALL & WINTER: OCTOBER 1 – APRIL 30
~~ ~~	G4	GOLDSTURM CONEFLOWER RUDBECKIA FULGIDA SULLIVANTII 'GOLDSTURM'	101	1 GAL.	EACH	NOT APPLICABLE	FULL & HEALTHY PLANT	SEASONAL APPLICATION DATES SPRING & SUMMER: MAY 1 – SEPTEMBER 30 NOT ALLOWED FALL & WINTER: OCTOBER 1 – APRIL 30
GROUND (COVERS							
	G 5	ASIATIC JASMINE TRACHELOSPERMUM ASIATICUM	162	4" CONT.	EACH	12" SPACING	FULL & HEALTHY PLANT	SEASONAL APPLICATION DATES SPRING & SUMMER: MARCH 1 – SEPTEMBER 30 FALL & WINTER: OCTOBER 1 – APRIL 30
SOD/SEED)							
\ \ \ \ \ \ \ \ \ \ \ \ \ \ \ \ \ \ \	SD1	CENTIPEDE SOD EREMOCHLOA OPHIUROIDES	4,164 SF	SOD	PER SQ. YD.	SOD CERTIFICATED REQ.; TO BE APPROVED BY ENGINEER	NOT APPLICABLE	SEASONAL APPLICATION DATES
								NOT APPLICABLE

ITEM	QTY
Bed Preparation	
APPLIED TO AREAS AS NOTED IN PLANS TO RECEIVE SHRUB PLANTING. ADD TREE BARK MULCH, TYPE III & ROTO-TILL INTO EXISITNG SOIL TO A MINIMUM DEPTH OF 6"	4,800 SF
Standard Ground Preparation	
APPLIED TO AREAS RECEIVING SOLID SOD	550 SY
Topsoil For Plant Holes	
3" DEPTH IN LANDSCAPE BED AREAS; 0.1 CU. YD. MIXED INTO BACKFILL FOR TREES NOT IN BED PREP AREA; SOIL BROUGHT TO SITE MUST BE STERILE AND WEED/SEED FREE	50 CY
Tree Bark Mulch, Type III	
3" DEPTH PLACED AND ROTO-TILLED INTO BED PREP AREAS	50 CY
Pine Straw	
1 BALE / 50 SQ. FT. OF BED PREP AREAS (USED IN SELECT LANDSCAPE BEDS; AS NOTED ON PLANS)	170 EA


Fertilizer Schedule				
Item	Quantity	Unit	Rates	Requirements
Fertilizer for Woody Plant Material, Tablet, 21 Gram	2	К	Per K	4 Per 15 / 30 Gal (56); 2 Per 3 Ga (584); 1 Per 1 Gal (1,007)
Fertilizer for Woody Plant Material, Tablet, 10 Gram	1	K	Per K	1 Per 4" Container (410)
Selective, Pre - Emergence Herbicide	5	LB.	Per LB.	2 Grams Per Sq Ft of Bed Prep Are Cost Absorbed in Bed Prep Pay Ite

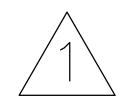

NOTICE TO DRAWING HOLDER
NEEL-SCHAFFER, INC., HEREINAFTER REFERRED TO AS THE
ENGINEER HAS PREPARED AND FURNISHED THIS DRAWING TO THE
OWNER FOR USE ON THIS PROJECT ONLY. THIS DRAWING SHOULD
NOT BE USED ON EXTENSIONS OF THIS PROJECT OR ON ANY OTHER
PROJECT. ANY REUSE OF THIS DRAWING, WITHOUT WRITTEN
VERIFICATION OR ADAPTATION BY THE ENGINEER, SHALL BE AT THE
REUSER'S SOLE RISK AND THE REUSER SHALL INDEMNIFY AND HOLD
HARMLESS THE ENGINEER FROM ALL CLAIMS, DAMAGES, LOSSES AND
EXPENSES, INCLUDING ATTORNEY'S FEES ARISING OUT OF OR
RESULTING THEREFROM.

			REVISIONS	DRAWING	INFORMATION				
NO.	DATE	BY	DESCRIPTION	N-S PROJECT NO.: 17697.000					
1	9/19/25	RPB	REVISED ASIATIC JASMINE QUANTITY	FILENAME: LANDSCAPE_dwg					
				SCALE: N.T.S.					
				SURVEYED BY: SOUTH COAST GEO					
				DSGN: PKT	DATE: 07/2024				
				DRWN: PKT	DATE: 07/2024				
				CHKD: RPB	DATE: 5/2025				
				QA/QC: GPC	DATE: 8/2025				

LIBRARY PLAZA AND FORREST AVENUE PEDESTRIAN PLAZA PHASE 2 STP-0210-00(044)LPA/109418-701000 UNIVERSITY OF SOUTHERN MISSISSIPPI HATTIESBURG, MISSISSIPPI FORREST COUNTY

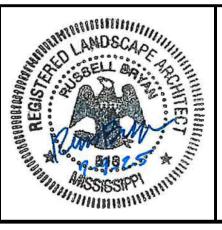






Addendum 2

LANDSCAPE QUANTITIES & VEGETATION SCHEDULE

WORKING NUMBER: DRAWING NUMBER: LS-4

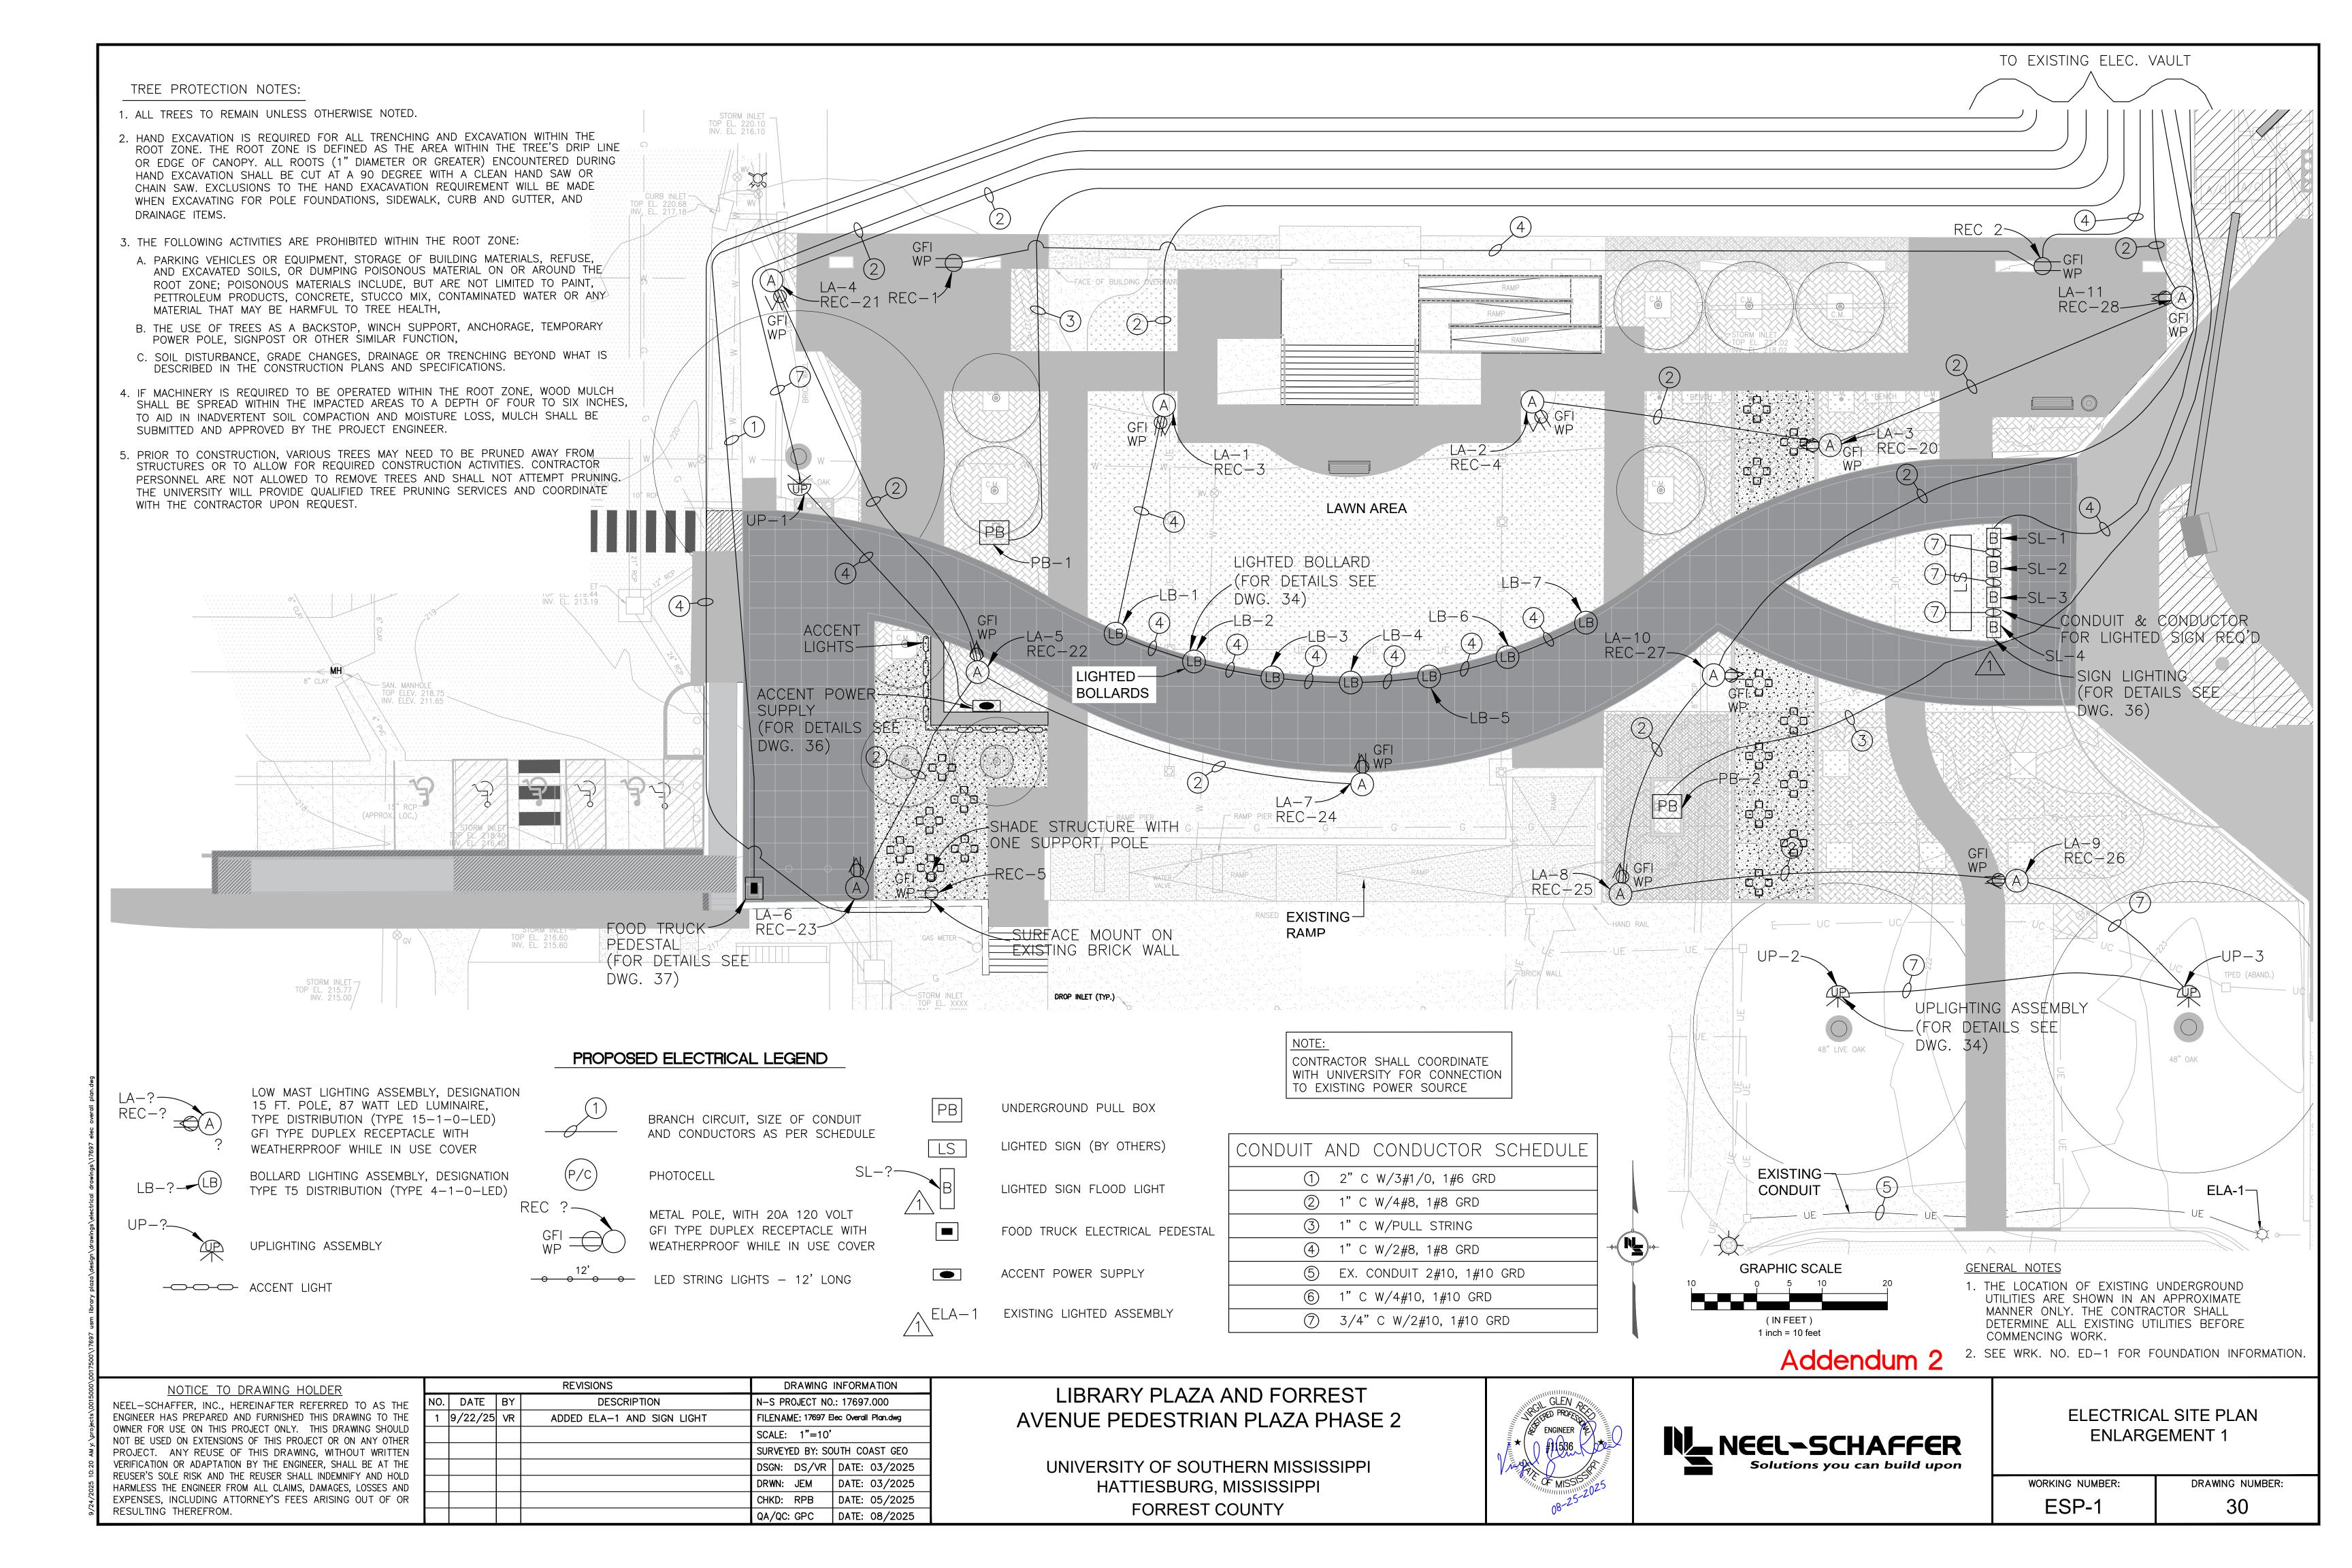

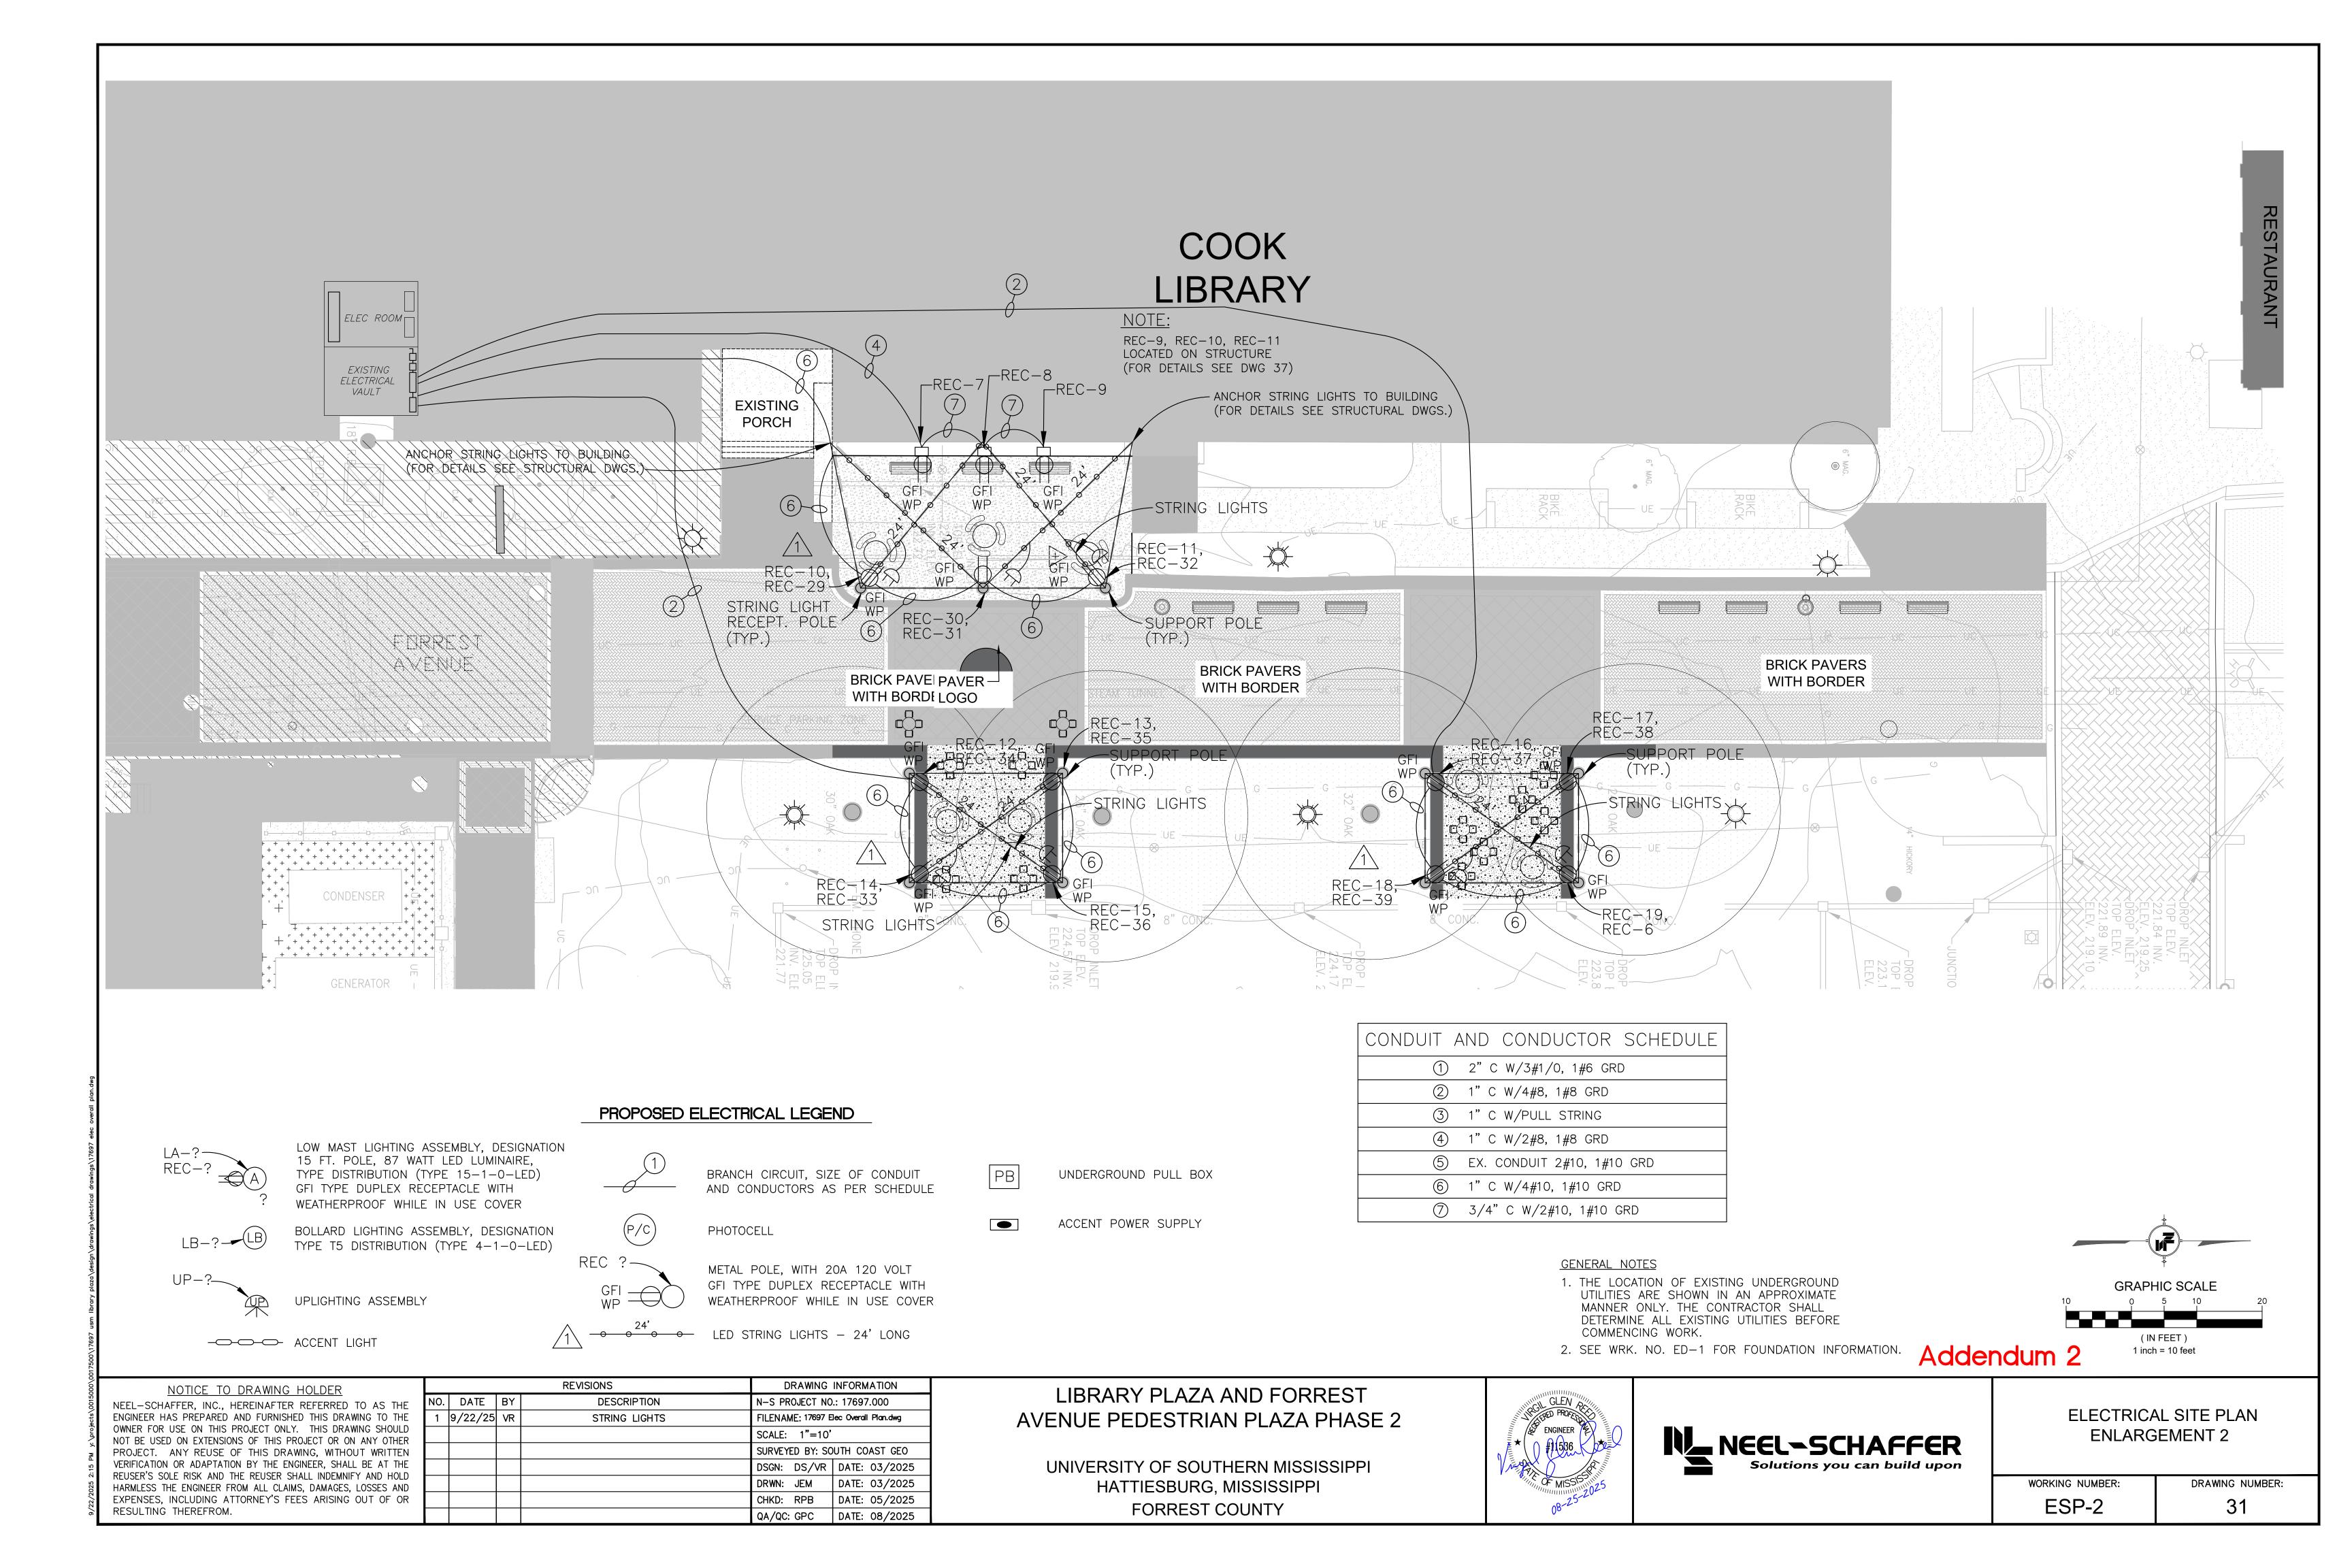

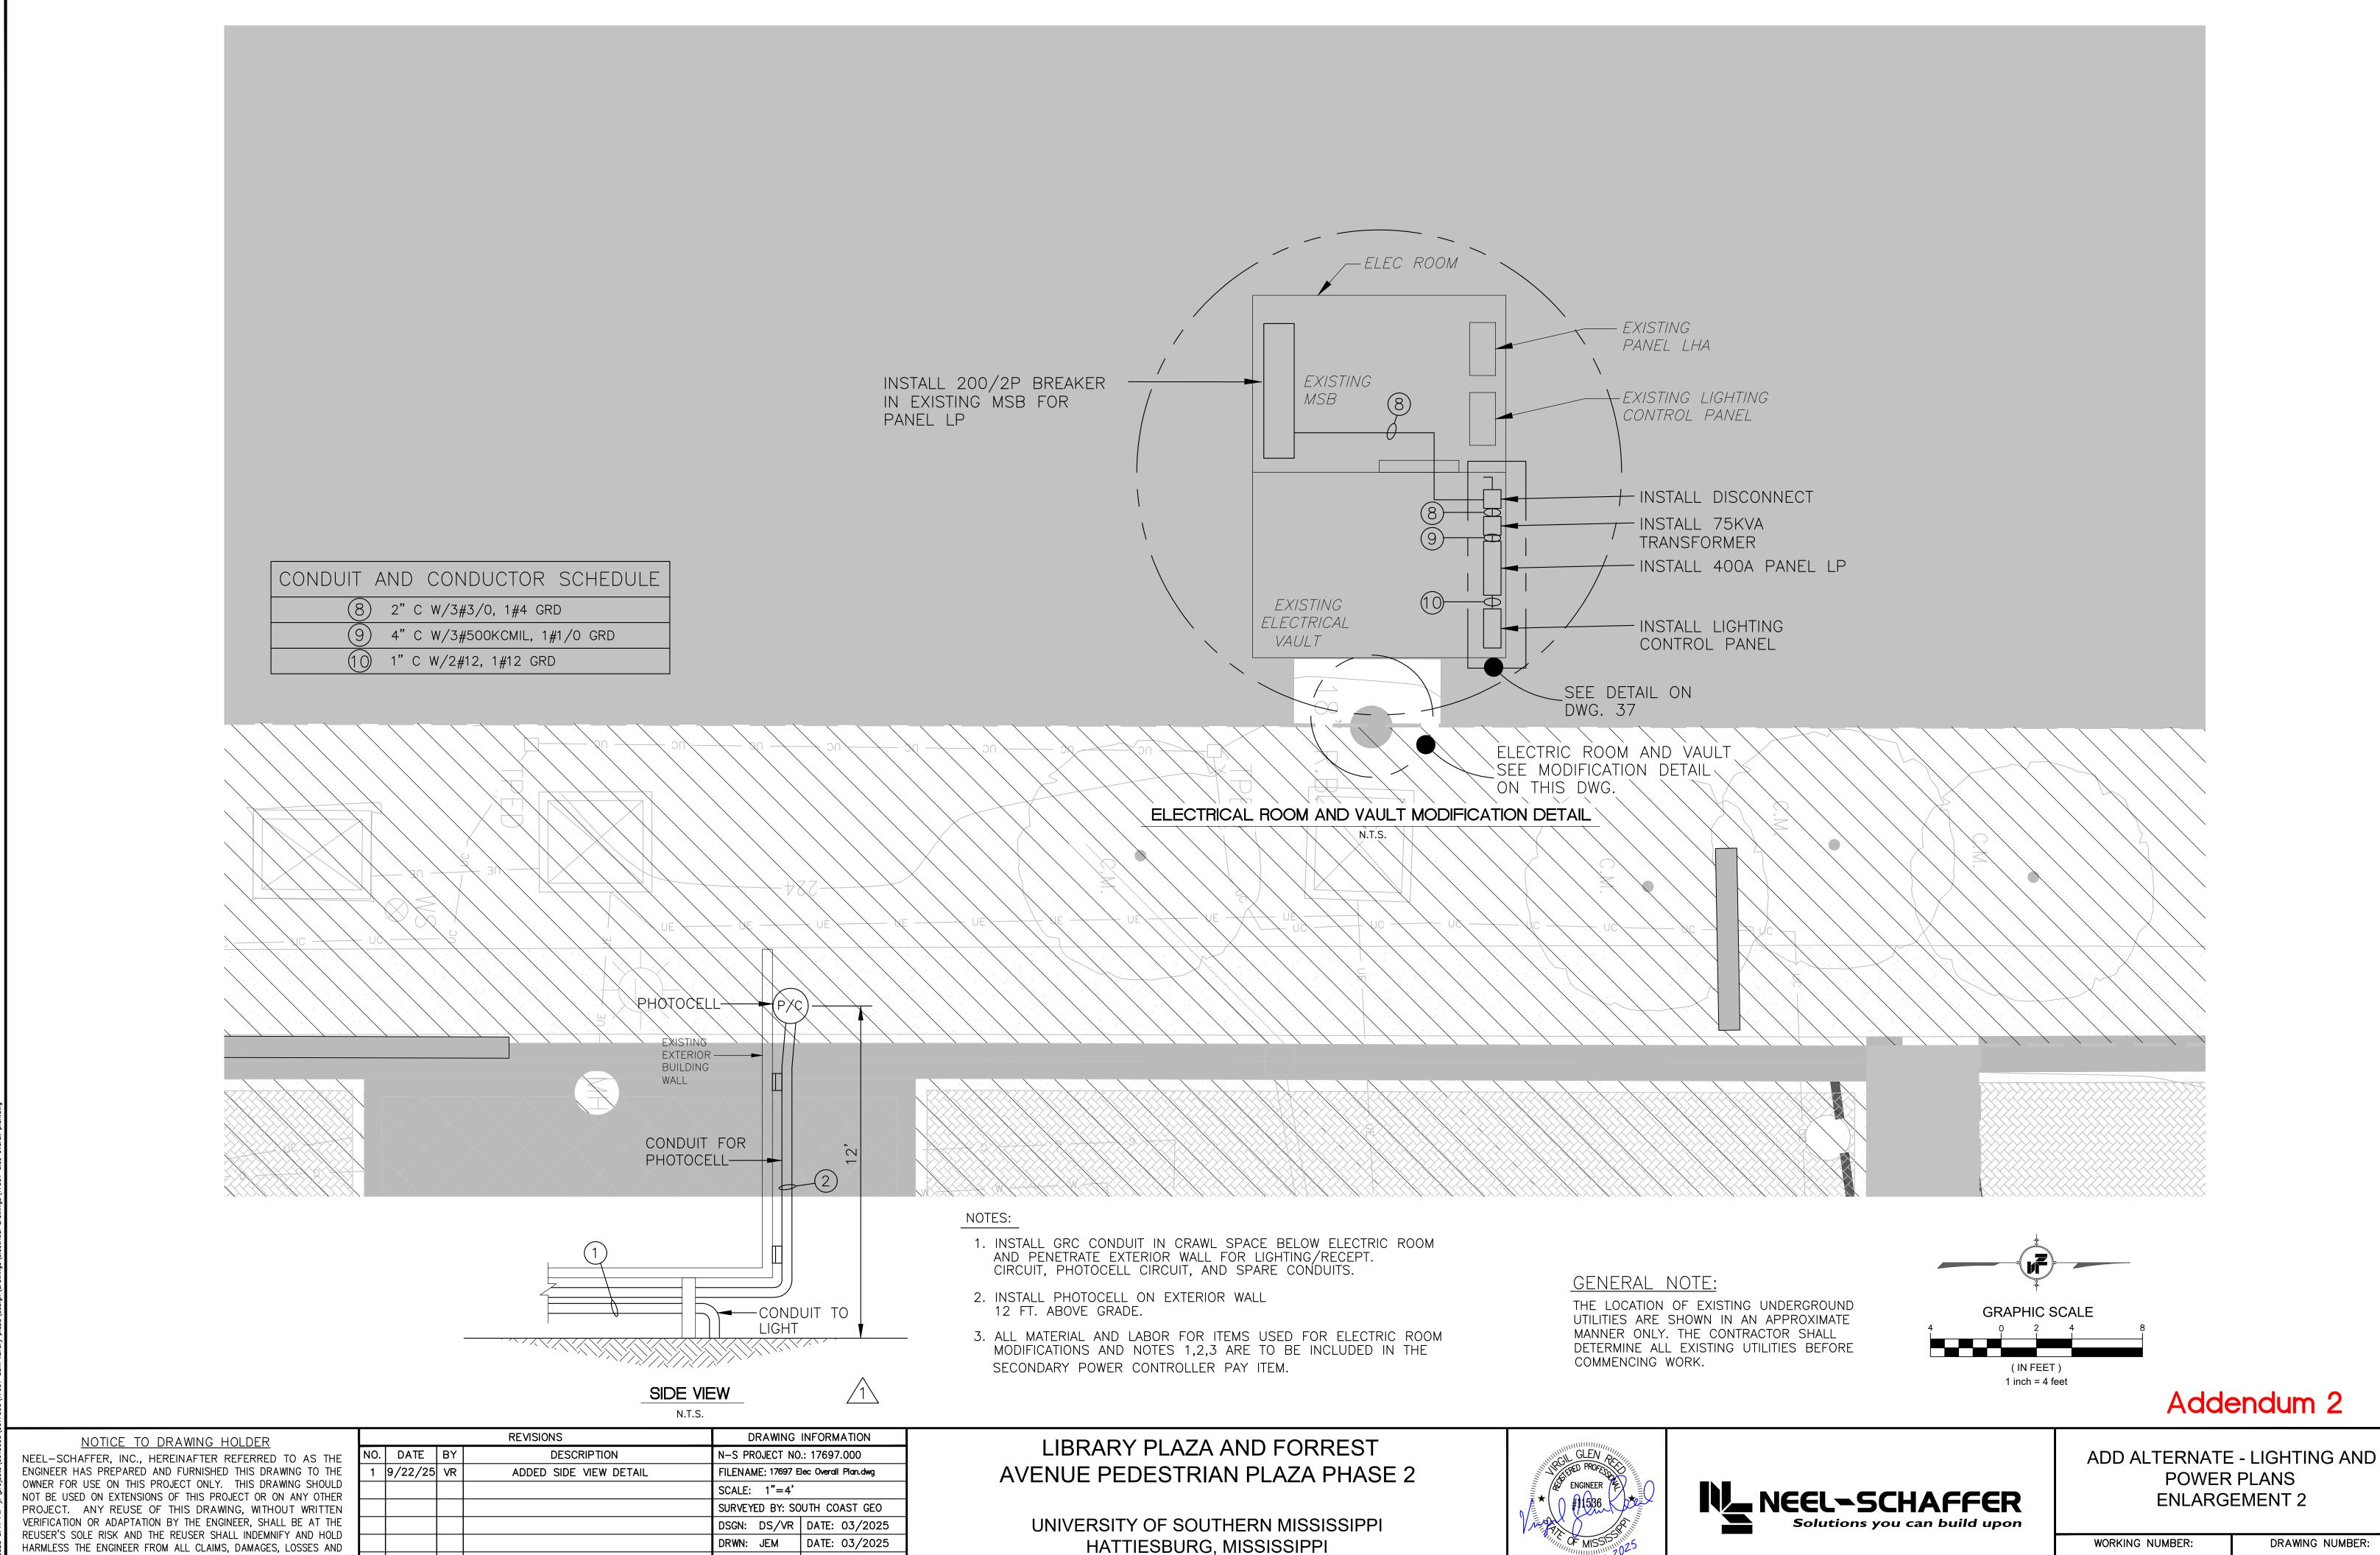

FORREST COUNTY

CHKD: RPB

DATE: 05/2025

QA/QC: GPC DATE: 08/2025

HARMLESS THE ENGINEER FROM ALL CLAIMS, DAMAGES, LOSSES AND EXPENSES, INCLUDING ATTORNEY'S FEES ARISING OUT OF OR


RESULTING THEREFROM.


WORKING NUMBER: DRAWING NUMBER: ESP-3

REQUIRED LIGHTING **MANUFACTURER 15' POST 15' POST LUMINAIRE** 9315TO/DBA/(DCO)/BK STERNBERG A850SRLED-6 ARC45T5-MDL014


NOTES:

- 1. DUPLEX OUTLET SHALL BE PROVIDED ABOVE POLE BASE.
- 2. ALL POLES, BASES, ARMS, BANNER ARMS, AND FINIALS SHALL BE
- POWDER COATED BLACK.
- 3. BANNER ARMS SHALL BE OF REMOVABLE TYPE.

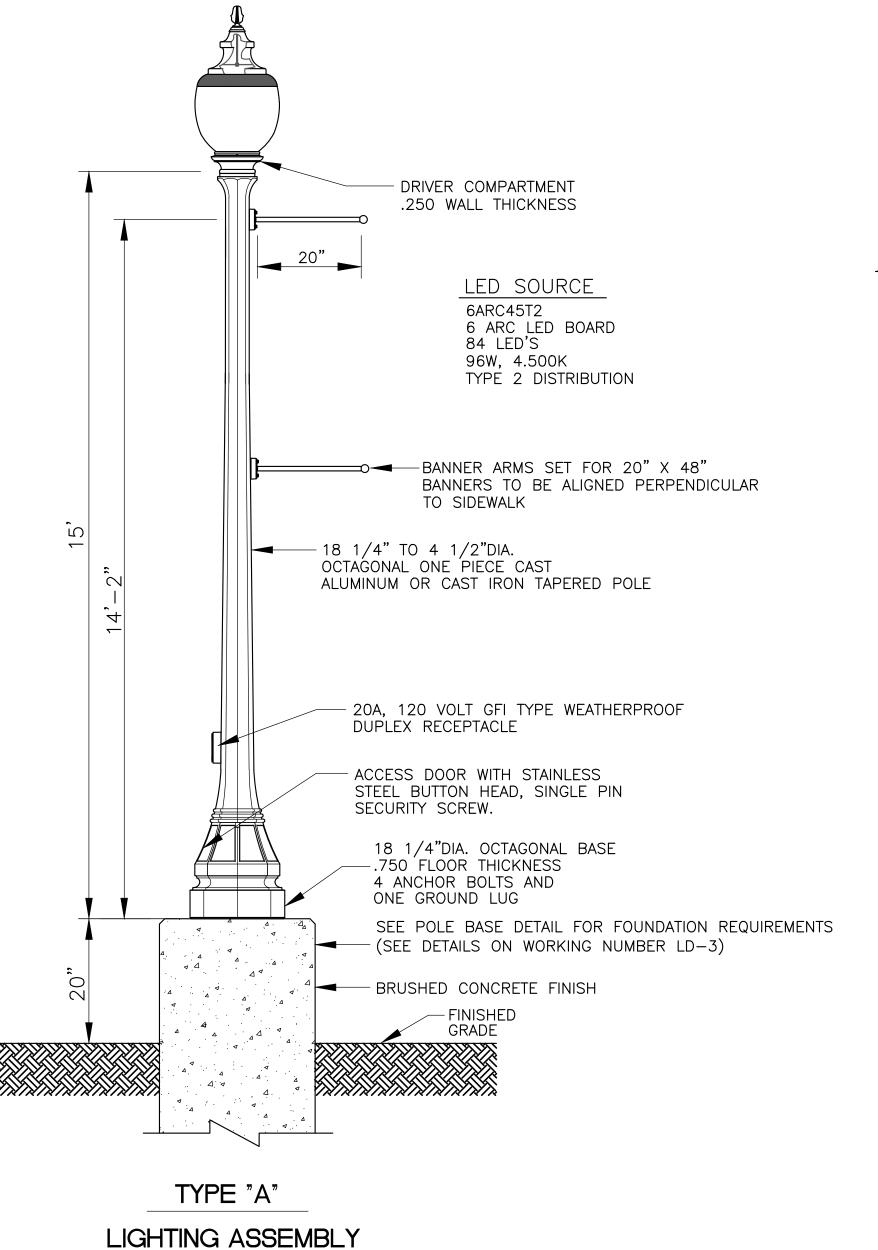

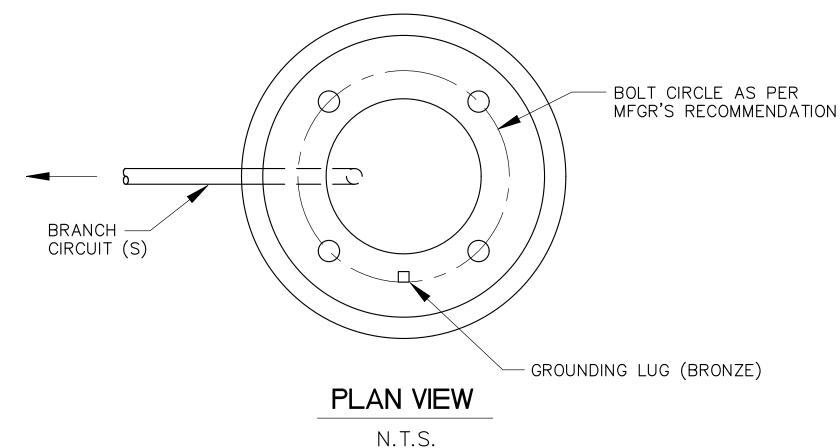

SCHEDULE - FOUNDATION								
POLE DESIGNATION	TYPE	Α						
Α	15-1-0-LED	30"						
\triangle 1								

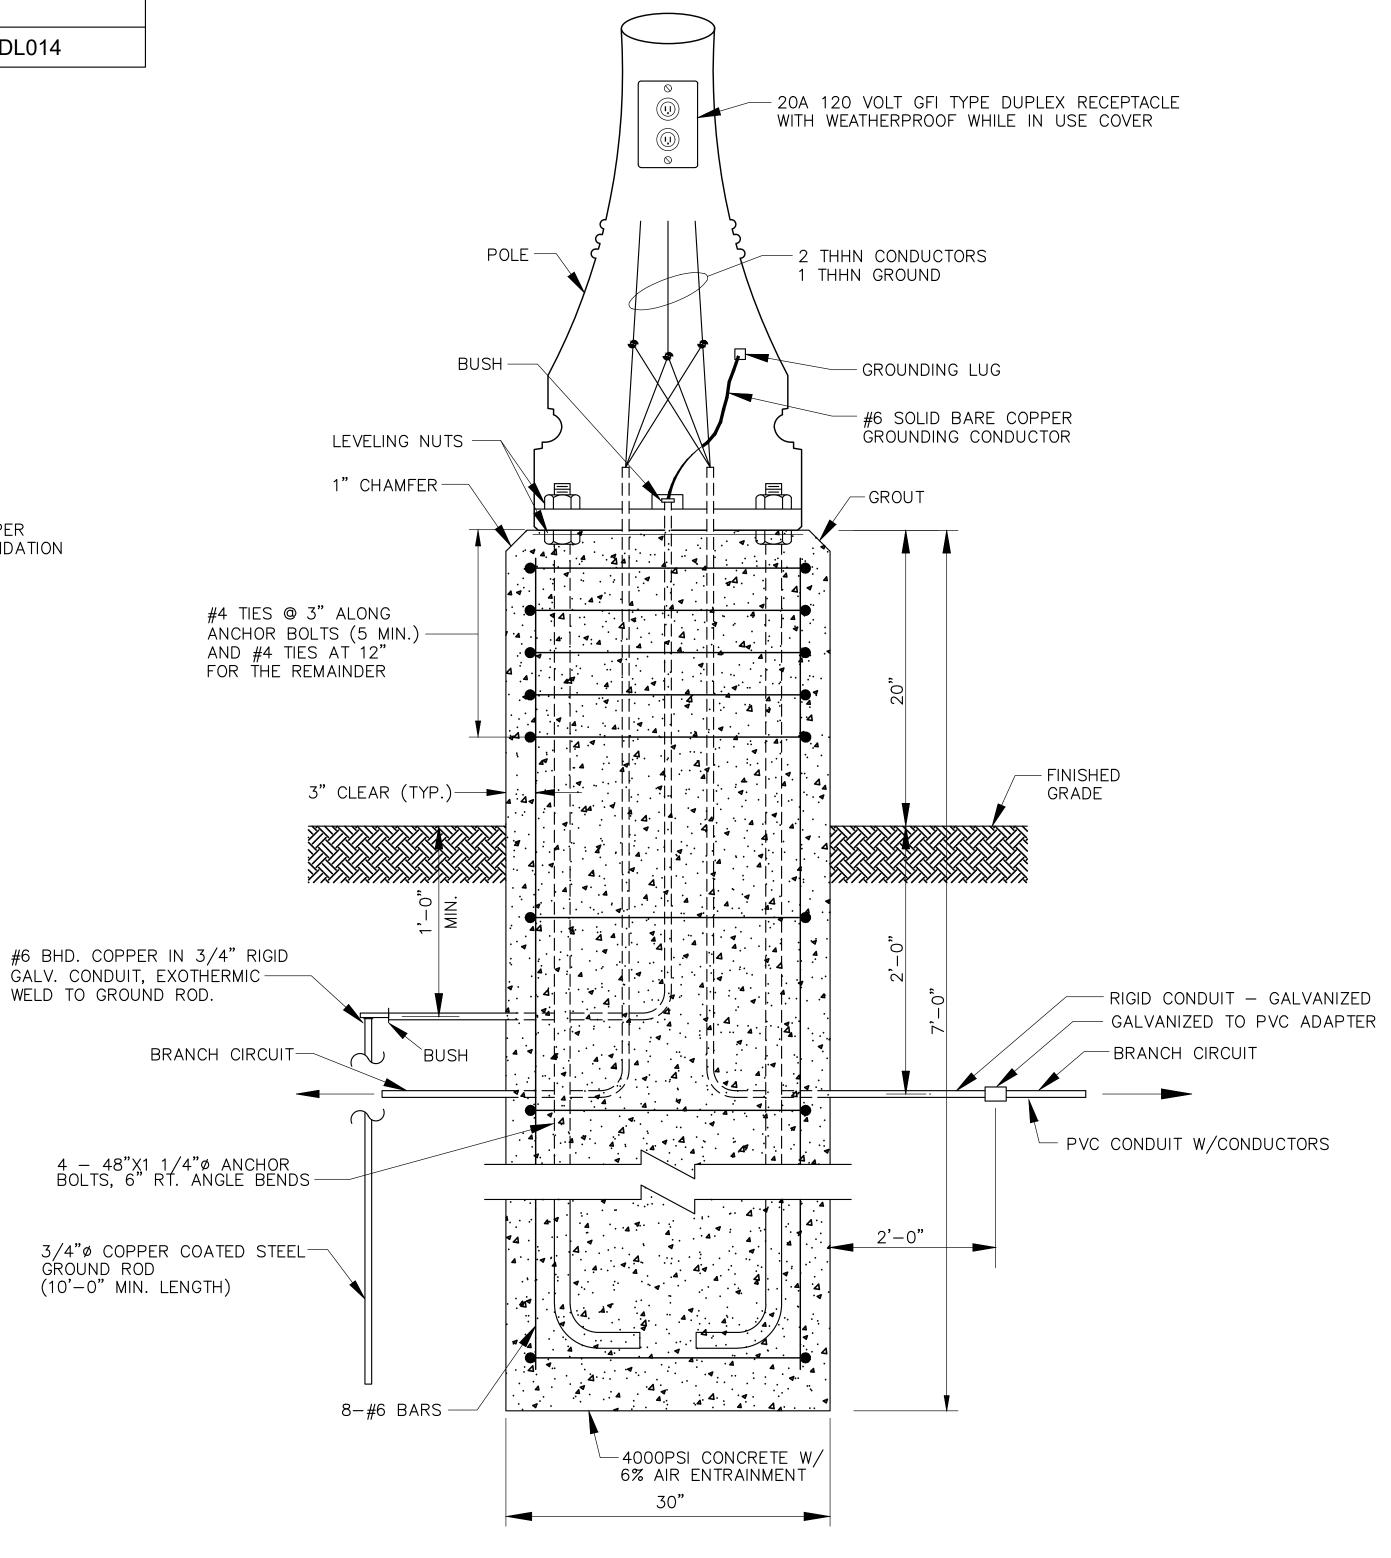

TYPE "A" - POLE BASE DETAIL N.T.S.

Addendum 2

NOTICE TO DRAWING HOLDER NEEL-SCHAFFER, INC., HEREINAFTER REFERRED TO AS THE ENGINEER HAS PREPARED AND FURNISHED THIS DRAWING TO THE OWNER FOR USE ON THIS PROJECT ONLY. THIS DRAWING SHOULD NOT BE USED ON EXTENSIONS OF THIS PROJECT OR ON ANY OTHER PROJECT. ANY REUSE OF THIS DRAWING, WITHOUT WRITTEN VERIFICATION OR ADAPTATION BY THE ENGINEER, SHALL BE AT THE REUSER'S SOLE RISK AND THE REUSER SHALL INDEMNIFY AND HOLD HARMLESS THE ENGINEER FROM ALL CLAIMS, DAMAGES, LOSSES AND EXPENSES, INCLUDING ATTORNEY'S FEES ARISING OUT OF OR RESULTING THEREFROM.

N.T.S.

				REVISIONS	D	RAWING	INFORMATION			
E	NO.	DATE	BY	DESCRIPTION	N-S PROJECT NO.: 17697.000					
E	1	9/22/25	VR	REVISED POLE DESIGNATION	FILENAME: 17697 Elec Details I.dwg					
D R					SCALE:	N.T.S.				
N					SURVEYED BY: SOUTH COAST GEO					
E D					DSGN:	DS/VR	DATE: 03/2025			
ט D					DRWN:	JEM	DATE: 03/2025			
R					CHKD:	RPB	DATE: 05/2025			
			·		QA/QC:	GPC	DATE: 08/2025			

LIBRARY PLAZA AND FORREST AVENUE PEDESTRIAN PLAZA PHASE 2


UNIVERSITY OF SOUTHERN MISSISSIPPI HATTIESBURG, MISSISSIPPI FORREST COUNTY







ELECTRICAL DETAILS I

WORKING NUMBER:	DRAWING NUMBER:
ED-1	33

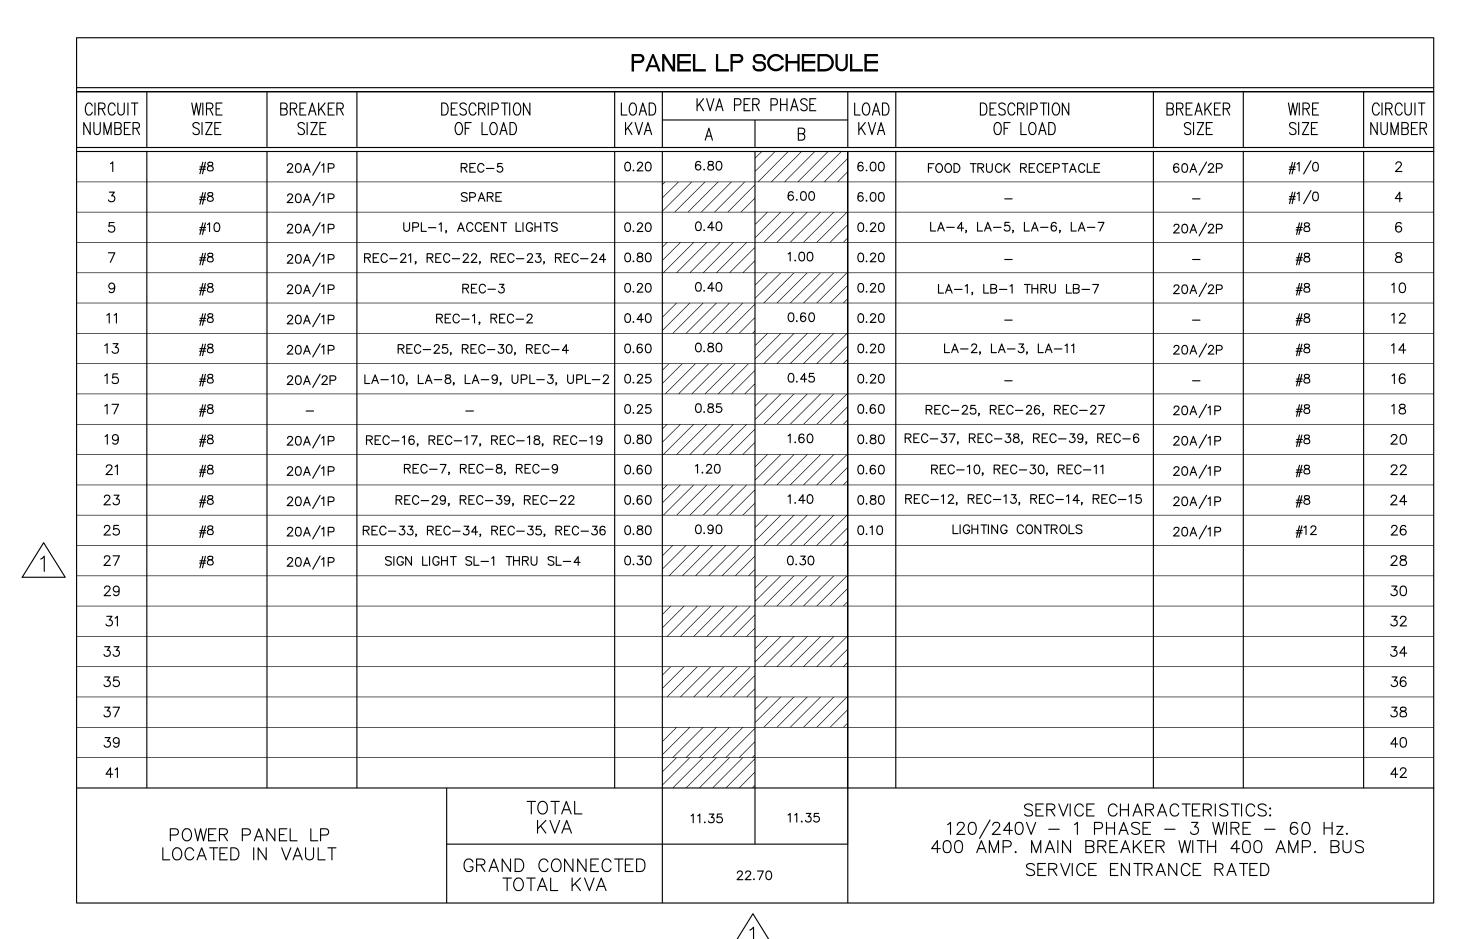

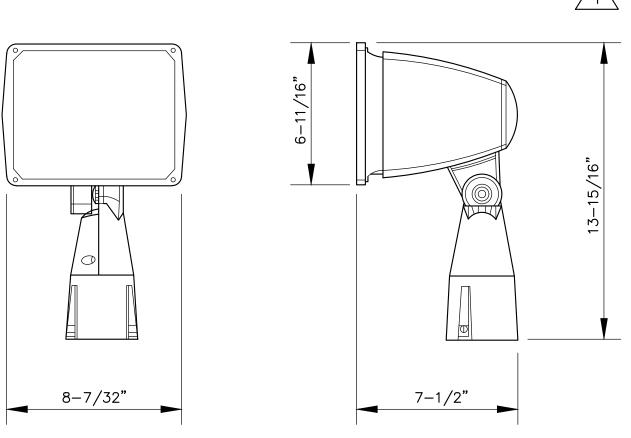


UPLIGHT DETAIL

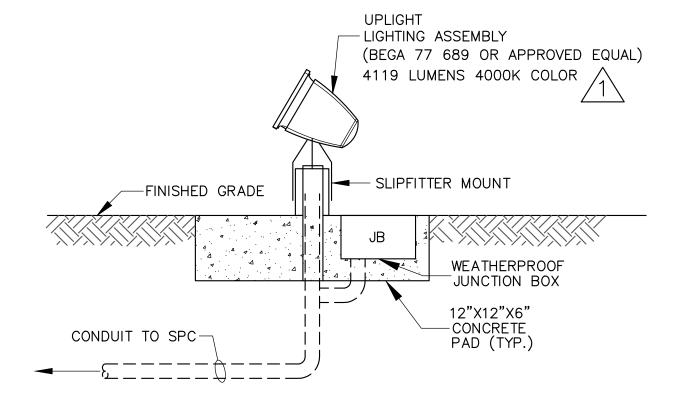

UPLIGHT FIXTURE C DETAIL

N.T.S.

REVISIONS DRAWING INFORMATION NOTICE TO DRAWING HOLDER NO. DATE BY DESCRIPTION N-S PROJECT NO.: 17697.000 NEEL-SCHAFFER, INC., HEREINAFTER REFERRED TO AS THE ENGINEER HAS PREPARED AND FURNISHED THIS DRAWING TO THE 9/22/25 VR REVISED REC NUMBER, FIXTURE INFORMATION FILENAME: 17697 Elec Details II.dwg OWNER FOR USE ON THIS PROJECT ONLY. THIS DRAWING SHOULD AND ADDED SIGN LIGHT SCALE: N.T.S. NOT BE USED ON EXTENSIONS OF THIS PROJECT OR ON ANY OTHER SURVEYED BY: SOUTH COAST GEO PROJECT. ANY REUSE OF THIS DRAWING, WITHOUT WRITTEN VERIFICATION OR ADAPTATION BY THE ENGINEER, SHALL BE AT THE DSGN: DS/VR | DATE: 03/2025 REUSER'S SOLE RISK AND THE REUSER SHALL INDEMNIFY AND HOLD DRWN: JEM DATE: 03/2025 HARMLESS THE ENGINEER FROM ALL CLAIMS, DAMAGES, LOSSES AND CHKD: RPB EXPENSES, INCLUDING ATTORNEY'S FEES ARISING OUT OF OR RESULTING THEREFROM. QA/QC: GPC DATE: 08/2025

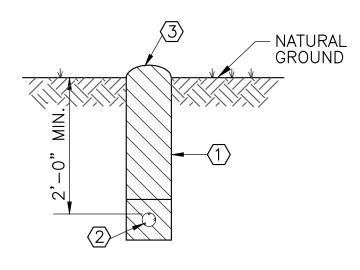



CABLE TRENCHING DETAIL

N.T.S.

- FRIABLE MATERIAL AS APPROVED BY THE ENGINEER COMPACTED 6" LIFTS.
- TYPE THWN CABLE IN PVC CONDUIT.
- PILE EXCESS 3" ABOVE GRADE FOR SETTLING OR AS DIRECTED BY ENGINEER.

DATE: 05/2025

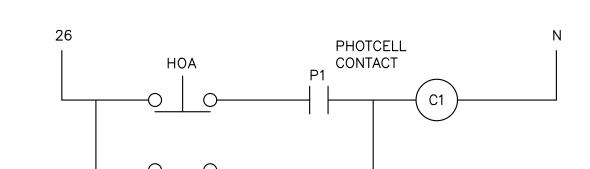


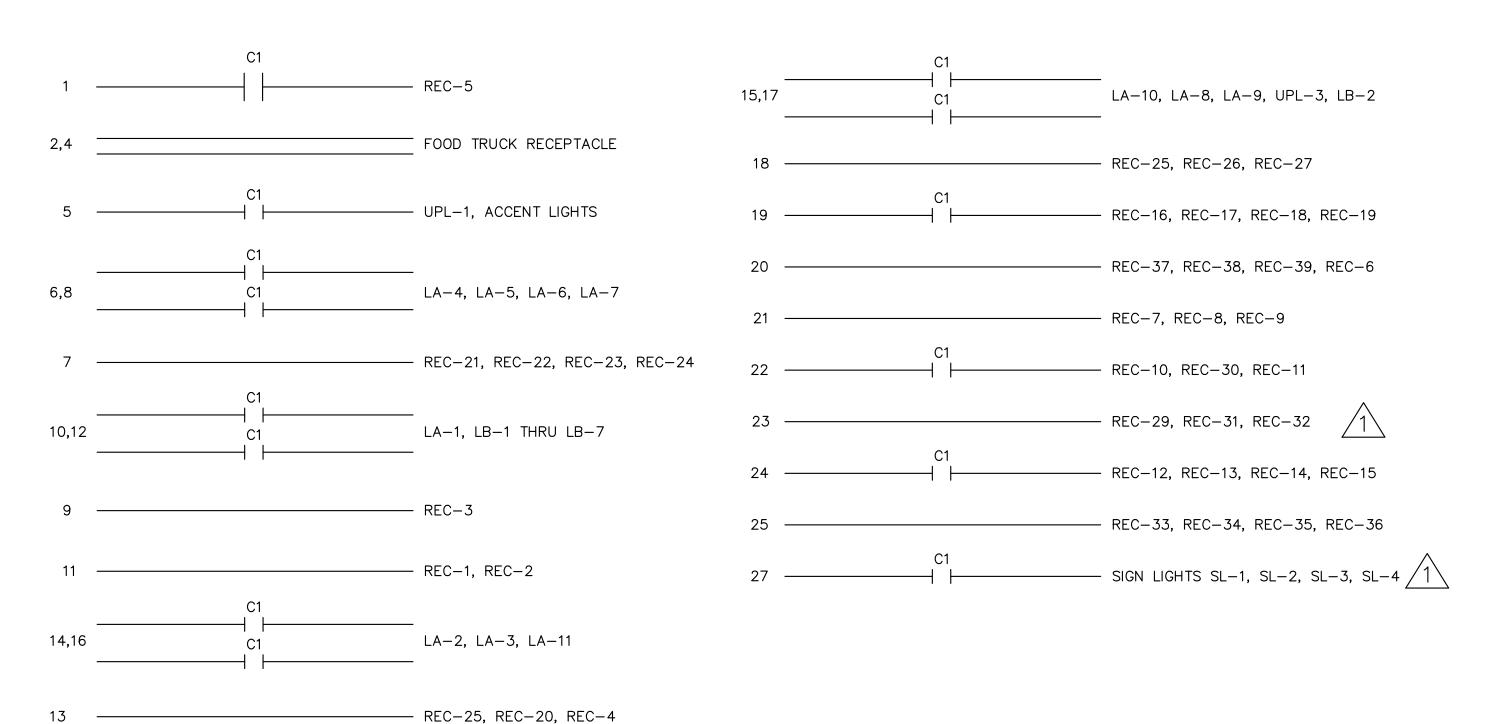

LIGHTING CONTROL CIRCUITS

ACCESS DOOR

N.T.S.

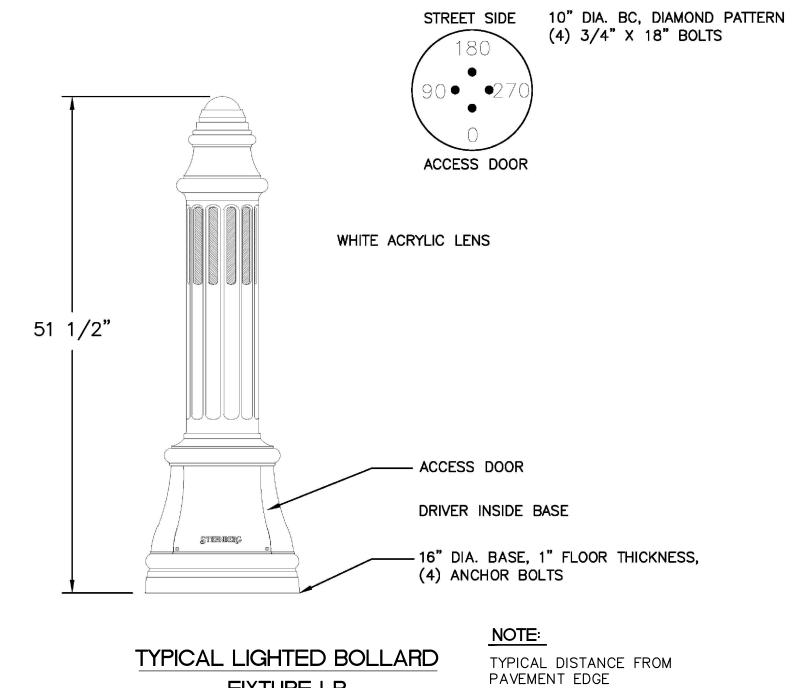

FIXTURE LB N.T.S.

APPROXIMATELY 1'-0"

FINISHED GRADE CONDUIT: └TO NEXT BOLLARD TO NEXT BOLLARD-3000 PSI CONCRETE AT 28-DAYS -NO REINFORCEMENT **─** 24"ø **─**

> FOUNDATION DETAIL N.T.S.

LIGHTED BOLLARD SHALL BE: STERNBURG 7701LED-1L40TS-MDL07/BKT OR APPROVED EQUAL

Addendum 2

LIBRARY PLAZA AND FORREST **AVENUE PEDESTRIAN PLAZA PHASE 2**


UNIVERSITY OF SOUTHERN MISSISSIPPI HATTIESBURG, MISSISSIPPI FORREST COUNTY








ELECTRICAL DETAILS II

WORKING NUMBER: DRAWING NUMBER: ED-2 34

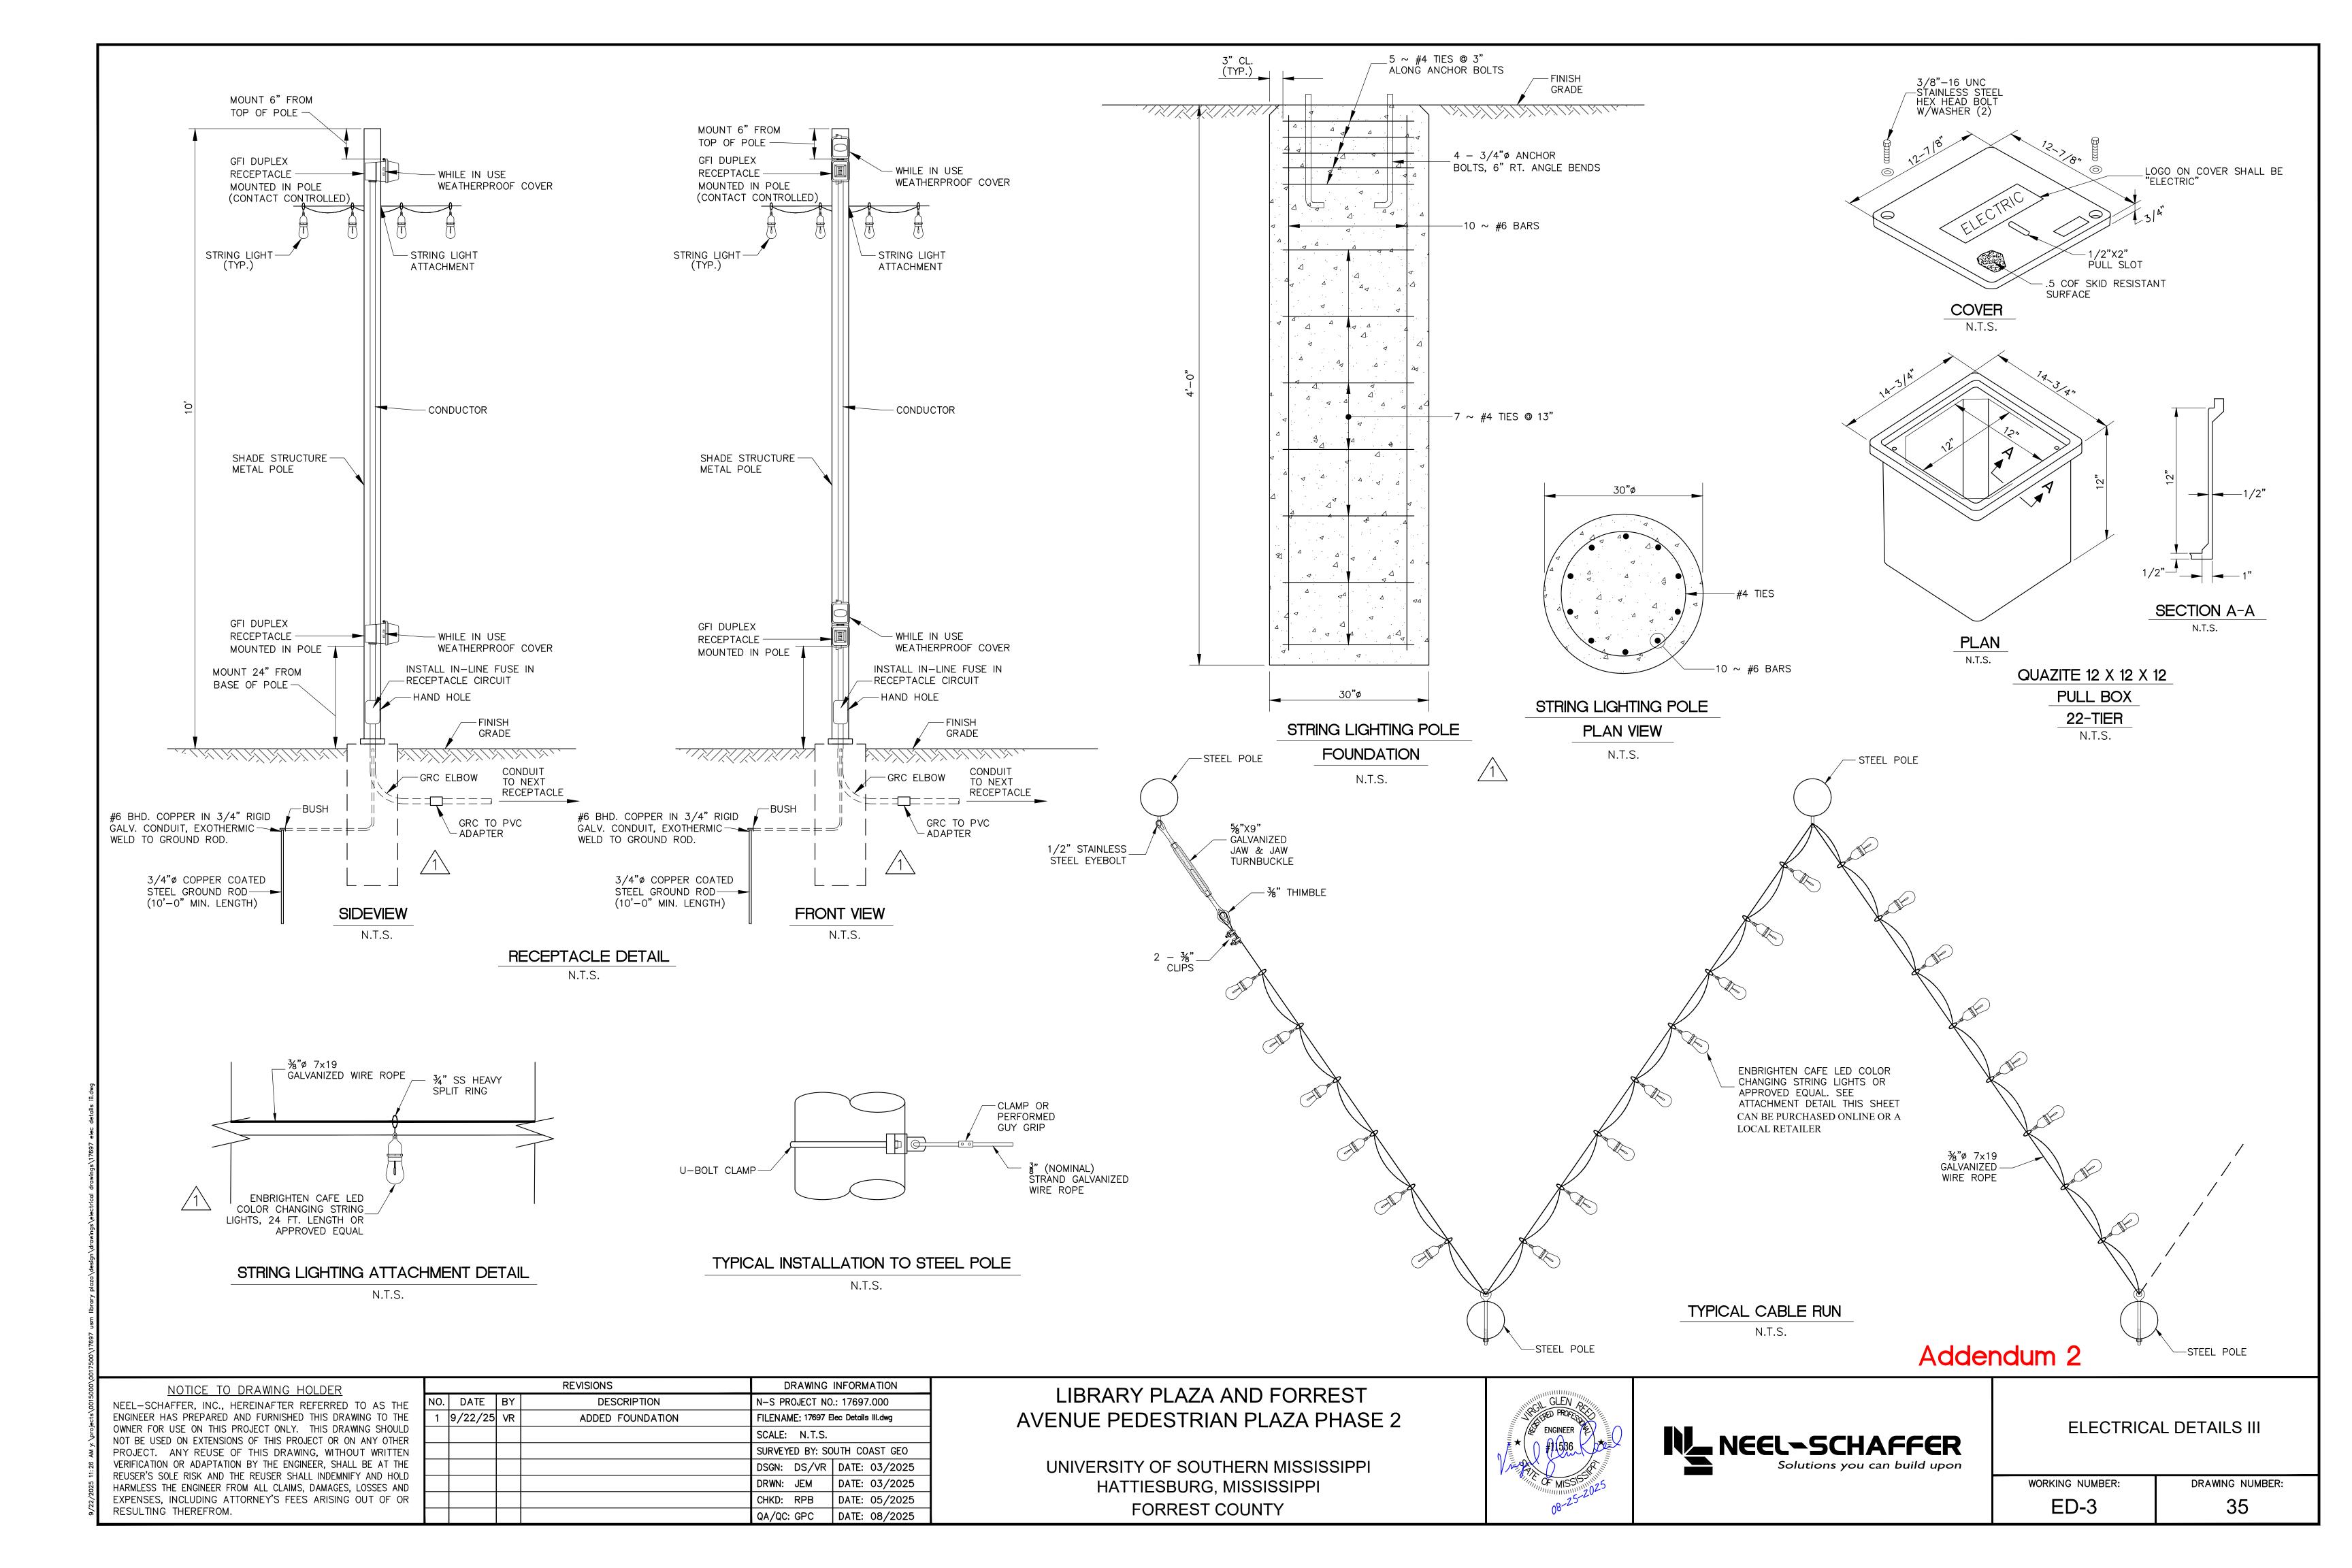


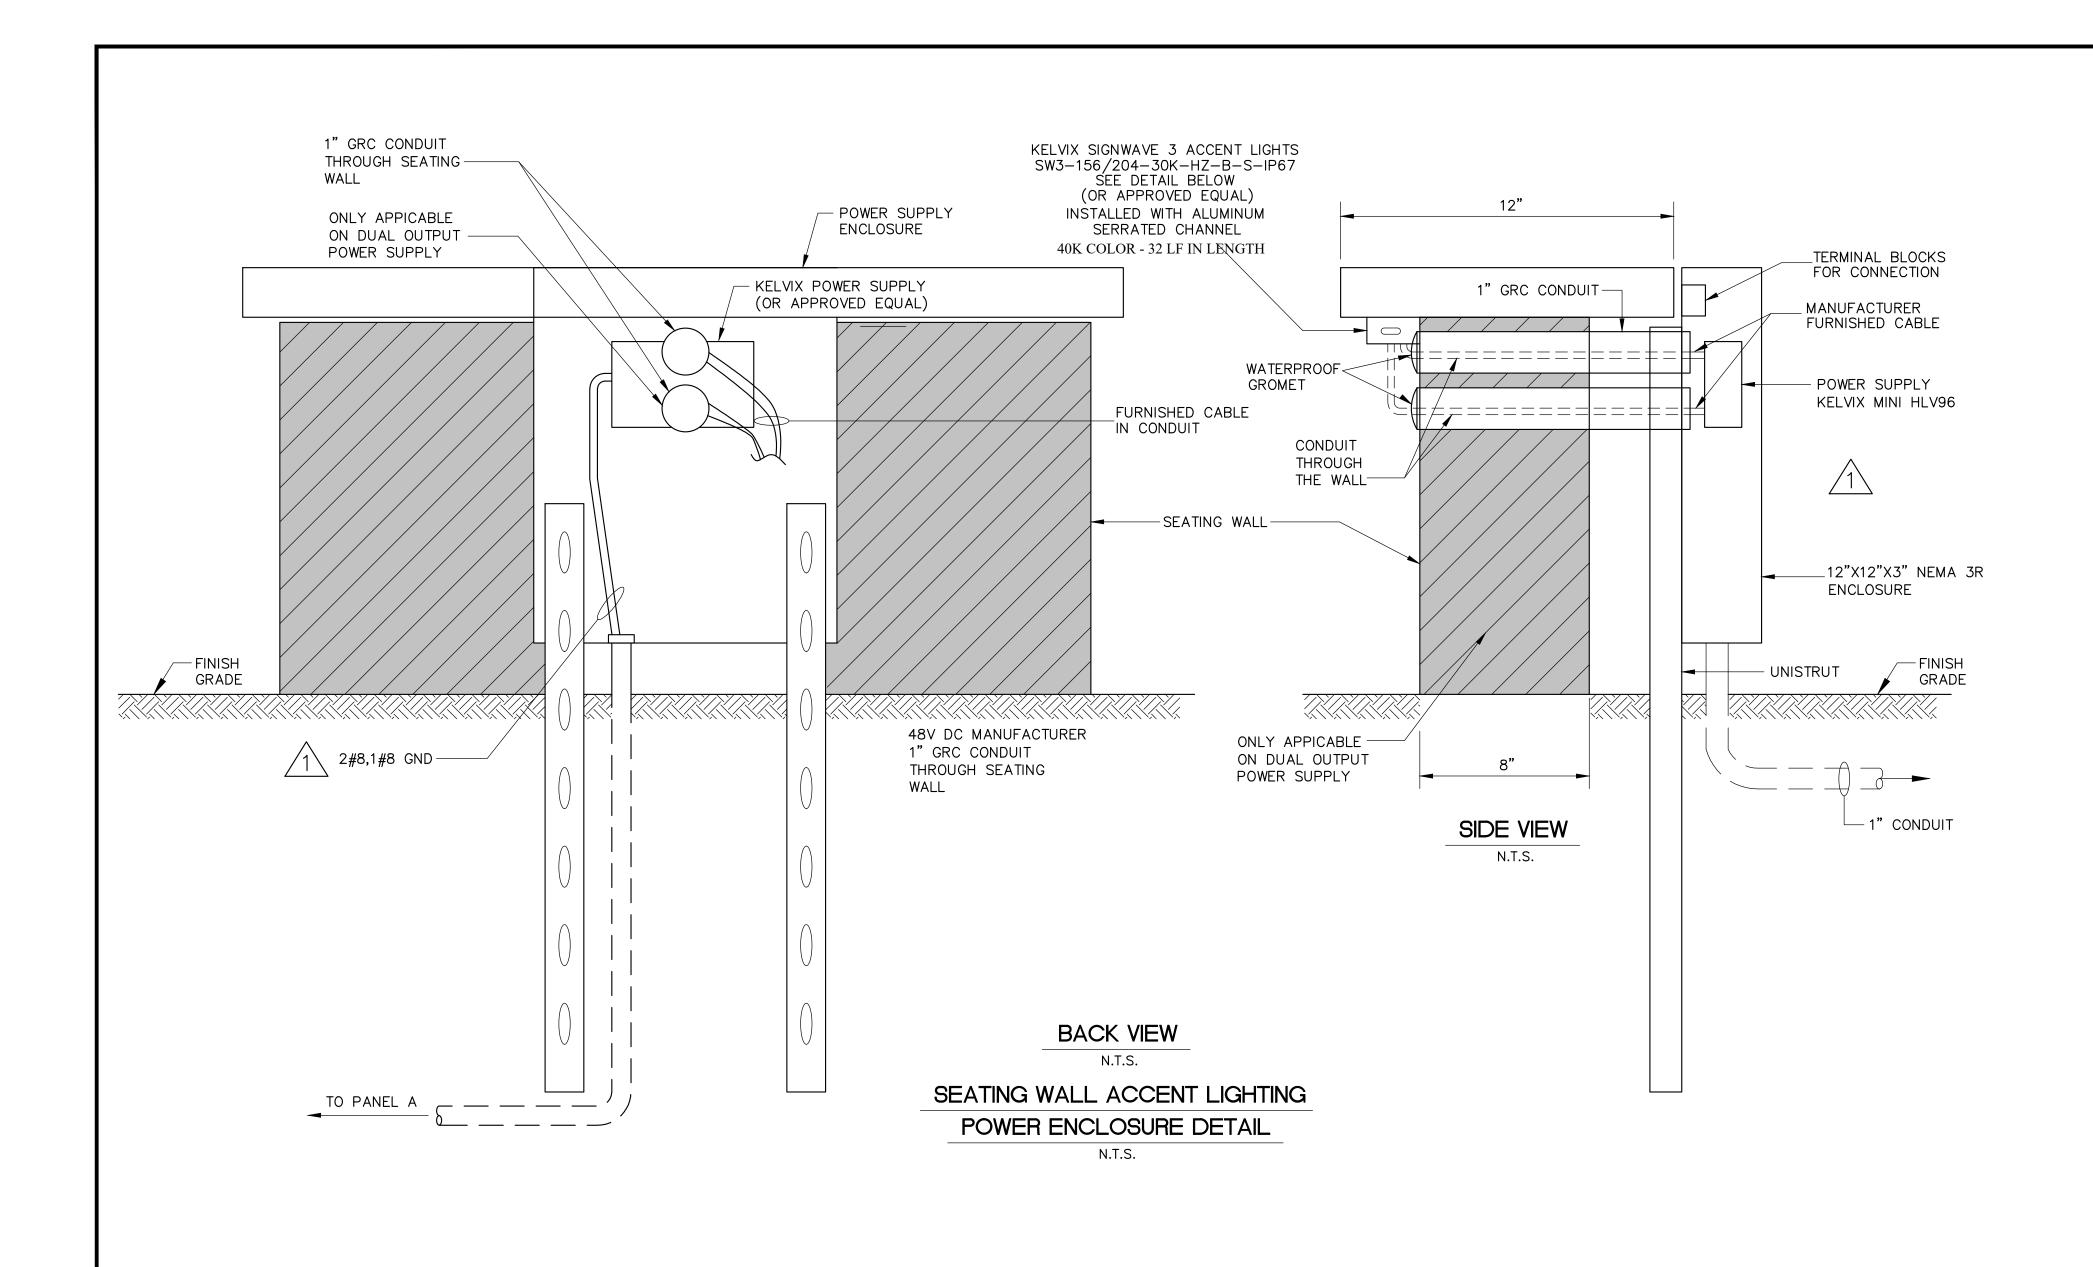

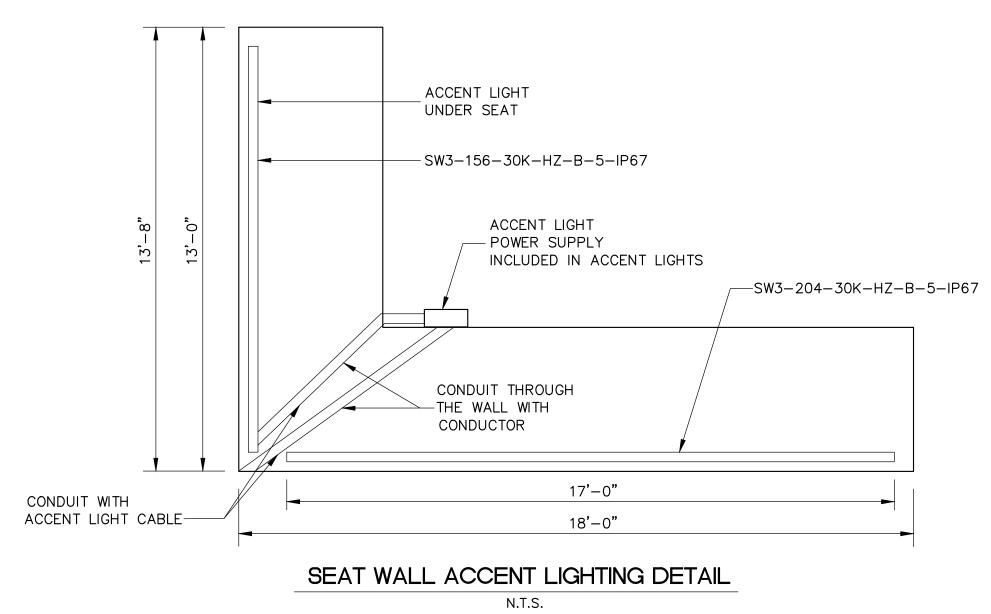

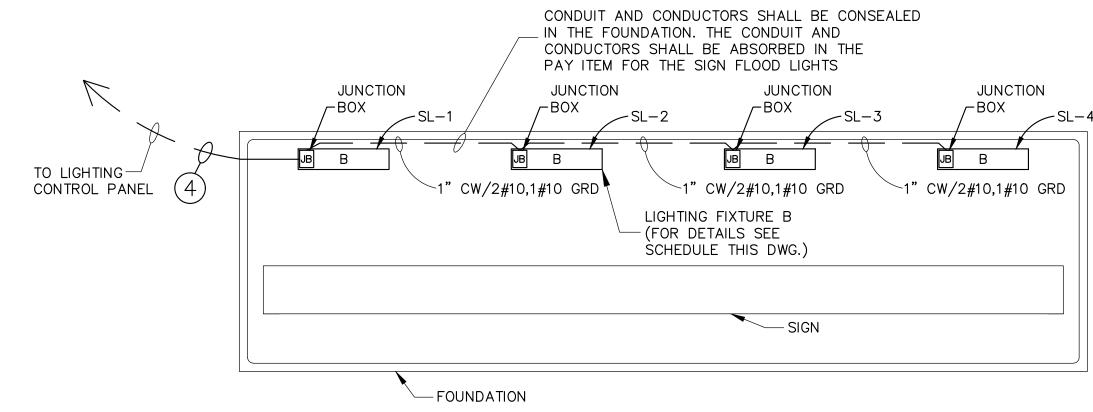

SIGN LIGHTING PLAN

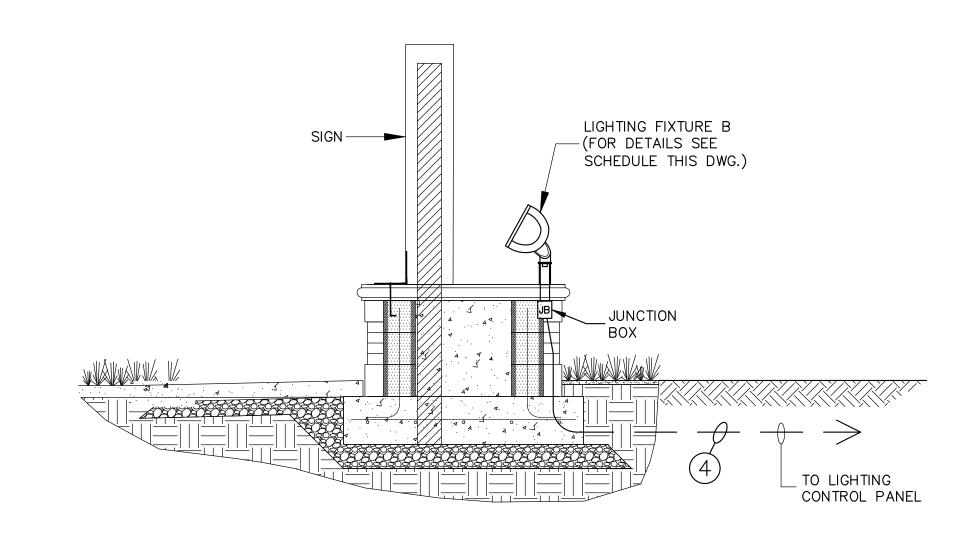

SIGN LIGHTING
SECTION ELECTRICAL

N.T.S.

LIGHTING FIXTURE SCHEDULE								
SYMBOL	DESCRIPTION	MANUFACTURER	CATALOG NUMBER	VOLTS	WATTS			
"B"	LINEAR FLOOD LIGHT	HYDREL	4750L-4FT-500LMF-40K-MVOLT WFL-KM	120	21			



Addendum 2

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			REVISIONS	DRAWING INFORMATION					
NO.	DATE	BY	DESCRIPTION	N-S PROJECT NO.: 17697.000					
1	9/22/25	VR	ADDED LIGHT DETAILS	FILENAM	lec Details IV.dwg				
				SCALE:	N.T.S.				
				SURVEY	ED BY: SC	UTH COAST GEO			
				DSGN:	DS/VR	DATE: 03/2025			
				DRWN:	JEM	DATE: 03/2025			
				CHKD:	RPB	DATE: 05/2025			
				QA/QC:	GPC	DATE: 08/2025			

LIBRARY PLAZA AND FORREST AVENUE PEDESTRIAN PLAZA PHASE 2

UNIVERSITY OF SOUTHERN MISSISSIPPI HATTIESBURG, MISSISSIPPI FORREST COUNTY





ELECTRICAL DETAILS IV

WORKING NUMBER: DRAWING NUMBER: 36

						i i	ESTIMA	TED Q	UANTI	TIES -	- LIGHTIN	G					
DESCRIPTION.		LOW MAST		FOOD TRK.	ACCENT	ACCENT LIGHTED		NUMBER OF			UNGD. E	BRANCH CK	T. AWG, FT.		FOUNDATION CON	NCRETE	UNDERGROUND
DESCRIPTION	Α	LB LIGHTED BOLLARD	UPLIGHTING ASSEMBLY	PEDESTAL	LIGHT 13'	17' FLOODLIG	HT WATTS	LUMINAIRES	4#1/0	5#8	1"CPULLSTRING	3#8	EX C3#10 5#10	3#10	30"		PULL BOX
LA-1	1						87	1		280					1.27		
LA-2	1						87	1		50					1.27		
LA-3	1						87	1		50 320					1.27		
LA-4 LA-5	<u> </u>						87 87	1		60					1.27		
LA-6	1						87	1		40					1.27		
LA-7	1						87	1		60					1.27		
LA-8	1						87	1		50					1.27		
LA-9	1						87	1		60					1.27		
LA-10 LA-11	1						87 87	1 1		220 150					1.27		
LA-11	ı						07	1		130					1.27		
LB-1		1										40					
LB-2 LB-3		1										20					
LB-3		1										20					
LB-5		1										20					
LB-6		1										20					
LB-7		1										20					
UP-1			1											350			
UP-2			1											50			
UP-3			1											50			
ACCENT					4												
LIGHTING					1	1						50					
FOOD TRK. PEDESTAL				1					350								
I EDESTAL																	
LIGHTED																	
SIGN						4						225					
FLOODLIGHT																	
														1			
														1			
PB-1											330						1
PB-2											260						1
														1			
														+			
ELA-1													100	1			
		7	7	A		4		1 1 1	750	1710	500	475	100	450	4.4		
TOTAL	11	/	3	1	1	1 4		11	350	1340	590	435	100	450	14		2

ESTIMATED QUANTITIES - RECEPTACLE									
GFCI DUPLEX			UNGD. BRANCH	CKT. AWG,	FT.				
RECEPTACLE	4#1/0	5#8	1"CPULLSTRING	3#8	3#10	5#10	3#10		
REC-1	············			150	,,				
REC-2				150					
REC-3		10							
REC-4		10							
REC-5						350			
REC-6						10			
REC-7				100					
REC-8							30		
REC-9							30		
REC-10						100			
REC-11						30			
REC-12		110							
REC-13						30			
REC-14						30			
REC-15						30			
REC-16		200							
REC-17						30			
REC-18						30			
REC-19						30			
REC-20		10							
REC-21		10							
REC-22							10		
REC-23							10		
REC-24							10		
REC-25		10							
REC-26		10							
REC-27		10							
REC-28		10				7.0			
REC-29						30			
REC-30						30			
REC-31						10			
REC-32		10				10			
REC-33		10							
REC-34		10							
REC-35		10							
REC-36		10	+						
REC-38		10							
REC-39		10							
110009		10							
TOTAL		460		400		740	90		




Addendum 2

REVISIONS			DRAWING INFORMATION			
NO.	DATE	BY	DESCRIPTION	N-S PROJECT NO.: 17697.000		
1	9/22/25	VR	ADDED QUANTITIES	FILENAME: 17697 Elec Qty.dwg		
				SCALE: N.T.S.		
				SURVEYED BY: SOUTH COAST GEO		
				DSGN:	DS/VR	DATE: 03/2025
				DRWN:	JEM	DATE: 03/2025
				CHKD:	RPB	DATE: 05/2025
	·	·		QA/QC:	GPC	DATE: 08/2025

LIBRARY PLAZA AND FORREST AVENUE PEDESTRIAN PLAZA PHASE 2

UNIVERSITY OF SOUTHERN MISSISSIPPI HATTIESBURG, MISSISSIPPI FORREST COUNTY

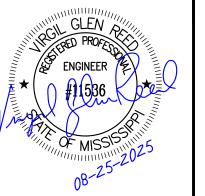



ESTIMATED LIGHTING- QUANTITIES

WORKING NUMBER:	DRAWING NUMBER:
EQL-1	38

GENERAL:

1. GENERAL BUILDING CODE: INTERNATIONAL BUILDING CODE, 2018 EDITION.

2. THE STRUCTURAL DRAWINGS AND SPECIFICATIONS ARE PART OF THE CONTRACT DOCUMENTS. THE CONTRACTOR SHALL OBTAIN ALL CONTRACT DOCUMENTS AND NOTIFY THE STRUCTURAL ENGINEER AND ARCHITECT OF ANY DISCREPANCIES OR OMISSIONS.

3. THE CONTRACTOR SHALL NOTIFY THE ARCHITECT AND ENGINEER PRIOR TO BIDDING OF ANY DISCREPANCY BETWEEN PLANS, DETAILS, AND/OR SPECIFICATIONS.

4. DESIGN LOADS:

A. DEAD LOADS:
SEE ARCHITECTURAL AND STRUCTURAL DRAWINGS FOR THE CONSTRUCTION
MATERIALS USED IN THE PROJECT. ANY CHANGES IN CONSTRUCTION MATERIALS
FROM THOSE SHOWN ON THE DRAWINGS SHALL BE REPORTED TO THE
STRUCTURAL ENGINEER FOR VERIFICATION OF THE CAPACITY OF THE
STRUCTURE.

B. *LIVE LOADS (psf):

STAIRS/EXITWAYS......100

5. CONTRACTOR SHALL VERIFY ALL DIMENSIONS AND SITE CONDITIONS PRIOR TO CONSTRUCTION AND SHALL NOTIFY ENGINEER IF ANY DISCREPANCIES ARE NOTED.

6. THE CONTRACTOR IS RESPONSIBLE FOR MEANS, METHODS, AND SEQUENCE OF CONSTRUCTION.

SITE PREPARATION:

1. ALL FOOTINGS AND FOUNDATIONS ARE DESIGNED FOR AN ALLOWABLE SOIL BEARING PRESSURE OF 1500 PSF. FOOTINGS ARE TO BEAR ON UNDISTURBED SOIL OR SATISFACTORY, COMPACTED STRUCTURAL FILL AS APPROVED BY THE GEOTECHNICAL ENGINEER.

2. CONTRACTOR TO INVESTIGATE ACTUAL LOCATIONS OF UNDERGROUND LINES AND UTILITIES BEFORE EXCAVATING, AND ADVISE ENGINEER OF ANY VARIATIONS. ALL EXCAVATIONS NEAR THESE LINES TO BE CARRIED OUT WITH EXTREME CAUTION.

3. RETAINING WALLS SHALL BE BACKFILLED WITH #57 CRUSHED STONE PLACED IN A 45-DEGREE WEDGE EXTENDING FROM THE BACK OF THE FOOTING HEEL. STONE SHALL BE COMPACTED IN 1'-0" MAX. LIFTS.

4. THE GENERAL CONTRACTOR SHALL OBTAIN A COPY OF THE GEOTECHNICAL REPORT FROM THE OWNER AND FOLLOW ALL REQUIREMENTS.

5. THE OWNER SHALL HIRE A GEOTECHNICAL ENGINEER TO REVIEW THE FOUNDATION BEARING SURFACE AND ENSURE THAT THE ALLOWABLE SOIL BEARING LISTED ABOVE THAT WAS USED IN THE STRUCTURAL DESIGN IS MET.

CONCRETE:

1. CONCRETE DESIGN CODE: BUILDING CODE REQUIREMENTS FOR STRUCTURAL CONCRETE - ACI 318-14.

2. UNLESS OTHERWISE NOTED ON THE DRAWINGS OR IN THE SPECIFICATIONS, CONCRETE SHALL DEVELOP A MINIMUM 28 DAY COMPRESSIVE STRENGTH OF 4,000 PSI.

3. UNLESS OTHERWISE NOTED, ALL DETAILING, FABRICATING STEEL SHALL BE GRADE 60, DEFORMED BARS, CONFORMING TO ASTM A615.

4. UNLESS OTHERWISE NOTED, ALL DETAILING, FABRICATION AND PLACING OF REINFORCING STEEL SHALL CONFORM TO THE MANUAL OF STANDARD PRACTICE FOR DETAILING REINFORCED CONCRETE STRUCTURES (ACI-SP-66-LATEST EDITION).

5. ALL BAR SPLICES SHALL BE CLASS 'B' TENSION SPLICES, AS SPECIFIED IN ACI 318-14, UNLESS OTHERWISE NOTED. REINFORCEMENT SHALL NOT BE WELDED UNLESS APPROVED BY THE ENGINEER.

		TENSION LAP SPLIC	E LENGTHS		
	BAR SIZE	fc=4000 psi			
		TOP BARS	OTHER BARS		
		В	В		
	#3	25"	19"		
	#4	33"	25"		
	#5	41"	31"		
	#6	49"	37"		
	#7	71"	54"		
	#8	81"	62"		
	#9	91"	70"		
	#10	102"	79"		
	#11	114"	87"		

NOTES:

ABOVE CHART IS APPLICABLE TO GRADE 60 REINFORCEMENT.
 TOP BARS ARE HORIZONTAL BARS WITH MORE THAN 12" OF FRESH CAST BELOW THE BAR.

3. WHEN BAR COVER IS EQUAL TO OR LESS THAN THE BAR DIAMETER OR THE BAR SPACING IS TWICE THE BAR DIAMETER OR LESS, SPLICE LENGTHS SHALL BE INCREASED BY 100%.

6. ALL EMBEDDED STRUCTURAL STEEL SHALL BE ASTM A36, UNLESS NOTED OTHERWISE. ANCHOR BOLTS SHALL BE A307 UNLESS NOTED OTHERWISE. ALL BOLTS IN CONTACT WITH PRESSURE TREATED WOOD SHALL BE GALVANIZED OR STAINLESS STEEL.

7. PROVIDE 2 - #4 DIAGONAL RODS IN THE TOP FACE OF SLAB ON GRADE AT ALL RE-ENTRANT CORNERS.

8. EXTEND REINFORCING BARS PAST RE—ENTRANT CORNERS A MINIMUM OF TENSION DEVELOPMENT LENGTH (Ld).

9. CHAMFER ALL EXPOSED EXTERNAL CORNERS OF CONCRETE WITH 3/4"x45 DEGREE CHAMFER, UNLESS NOTED OTHERWISE.

10. UNLESS OTHERWISE NOTED, REINFORCE ALL CONCRETE SLABS ON GRADE (INCLUDING SIDEWALKS) WITH 6 \times 6 - W2.9 \times W2.9 WELDED WIRE FABRIC AT MID-DEPTH OF SLAB.

12. WELDED WIRE FABRIC REINFORCING SHALL LAP TWO FULL MESHES AND BE SECURELY WIRED AT EACH SIDE AND END.

13. CONTRACTOR TO REFER TO DRAWINGS OF OTHER TRADES AND VENDOR DRAWINGS FOR EMBEDDED ITEMS AND RECESSES NOT SHOWN ON THE STRUCTURAL DRAWINGS.

14. SHEAR KEYS TO BE 2x4 NOMINAL UNLESS OTHERWISE NOTED.

16. PROVIDE CORNER BARS TO SPLICE WITH ALL CONTINUOUS

17. ALL CONCRETE SHALL BE CURED USING WET METHODS OR CURING COMPOUND PER ACI 301. COMPLY WITH ACI 301 FOR MIXING, TRANSPORTING, FORMING, PLACING, AND CURING CONCRETE.

18. FOR PEDESTAL AND VERTICAL WALL REINFORCING, DOWEL TO FOUNDATION WITH HOOKED BARS OF THE SAME SIZE AND SPACING AS VERTICAL BARS.

19. ALL EPOXY SHALL CONFORM TO THE REQUIREMENTS OF HILTI HY 200 OR APPROVED EQUAL.

20. CONCRETE MIX REQUIREMENTS:

-PORTLAND CEMENT: ASTM 150, TYPE 1
-FLY ASH; CLASS F OR C (25% OF CEMENTITIOUS MATERIALS

MAXIMUM)
-AGGREGATE: ASTM 33

-MAXIMUM W/C/ RATIO: 0.48
-MINIMUM CEMENTITIOUS MATERIAL: 520LB/CU. YD.

-SLUMP LIMIT: 4" ±1", 8" WITH VERIFIED SLUMP OF 2 TO 4 INCHES

BEFORE ADDING HIGH RANGE WATER REDUCING ADMIXTURE OR PLASTICIZING ADMIXTURE, ±1 INCH.

-AIR CONTENT: NOT TO EXCEED 6%.

Addendum 2


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	REVISIONS			DRAWING INFORMATION		
NO.	DATE	BY	DESCRIPTION	N-S PROJECT NO.: 17697.000		
1	9/19/25	мск	HANDRAIL ANCHOR	FILENAME: S-1.dwg		
				SCALE: N.T.S.		
				SURVEYED BY: SOUTH COAST GEO		
				DSGN: MCK	DATE: 05/2025	
				DRWN: MCK	DATE: 05/2025	
				CHKD: RPB	DATE: 05/2025	
				QA/QC: GPC	DATE: 8/2025	

LIBRARY PLAZA AND FORREST AVENUE PEDESTRIAN PLAZA PHASE 2


UNIVERSITY OF SOUTHERN MISSISSIPPI HATTIESBURG, MISSISSIPPI FORREST COUNTY




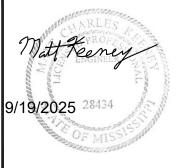


STRUCTURAL NOTES
AND DETAILS


WORKING NUMBER: DRAWING NUMBER: 39

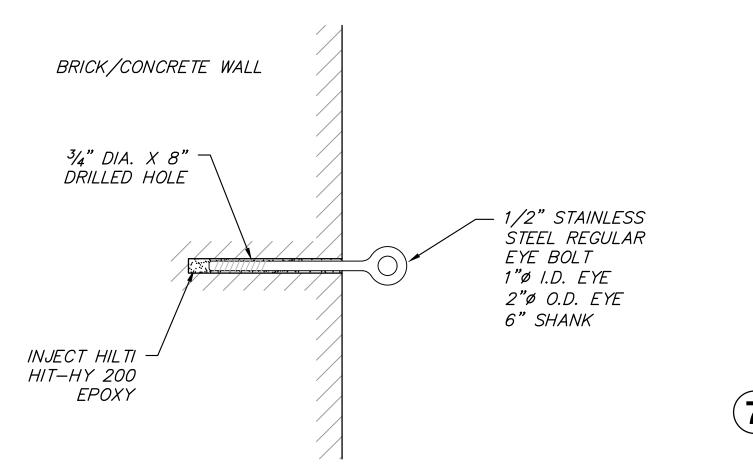

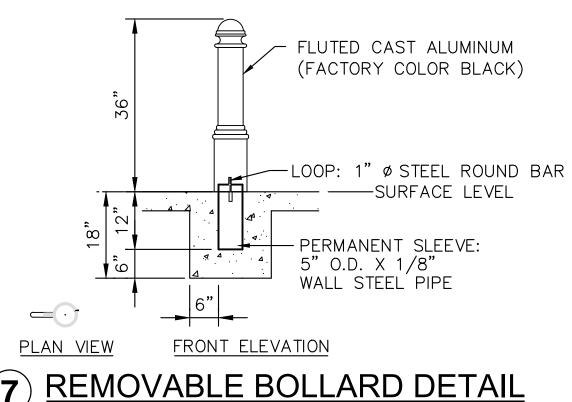

NOT TO SCALE

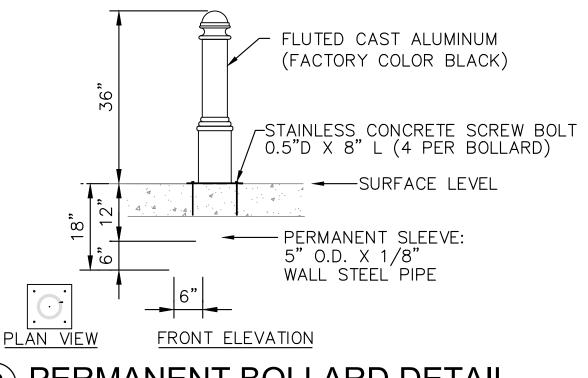

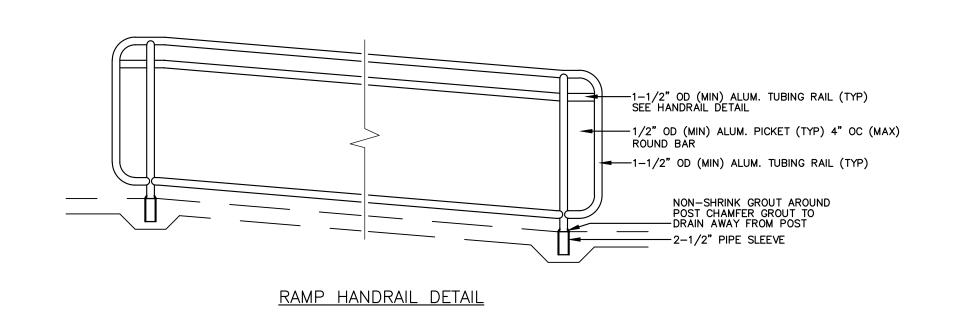


PERMANENT BOLLARD DETAIL

NOT TO SCALE

RAMP HANDRAIL TYPICAL DETAIL


NOT TO SCALE


(6) TYPICAL EYE BOLT INSTALLATION IN BUILDING WALL

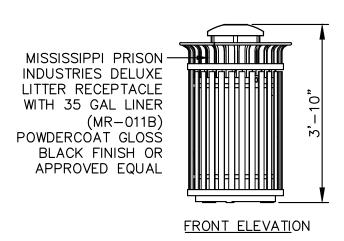





PLAN VIEW

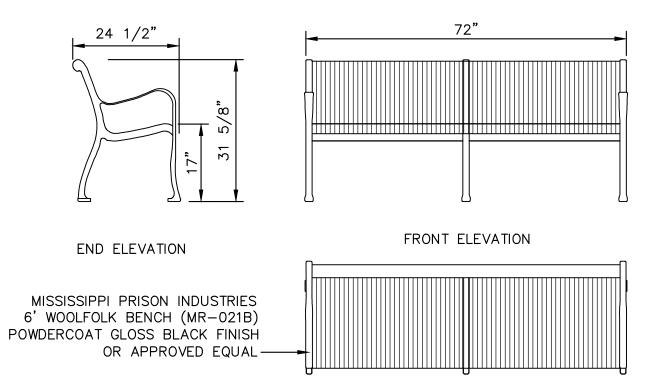


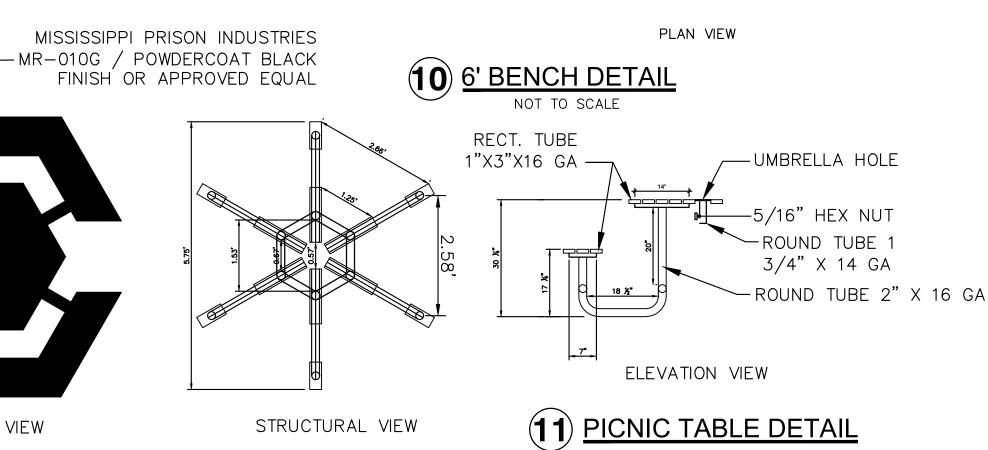

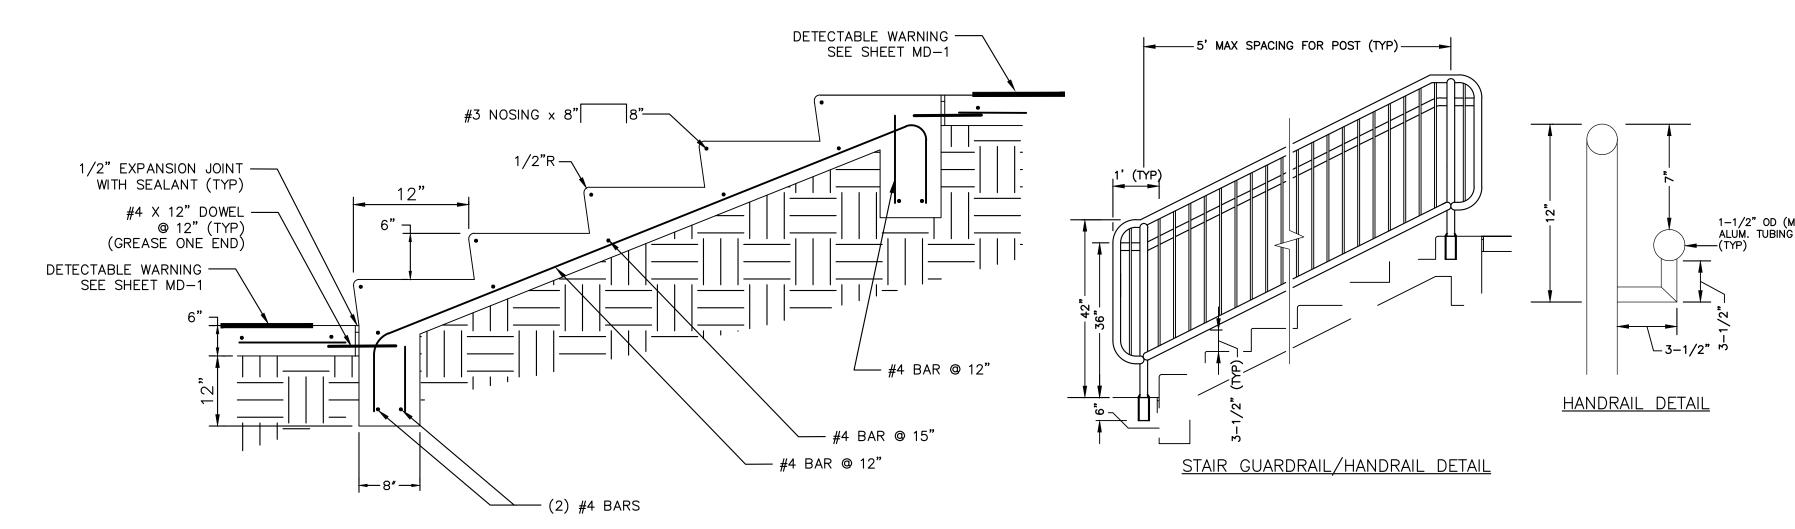

13 TYPICAL CONCRETE STAIR & RAIL DETAILS

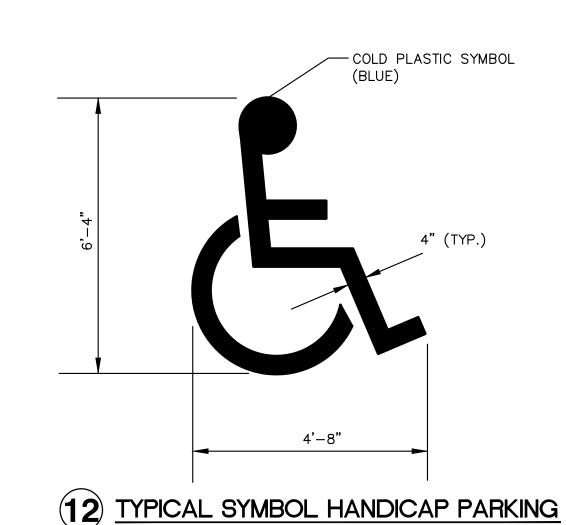

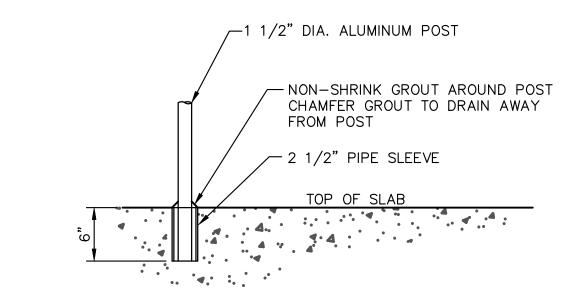

CONCRETE STRUCTURE (EMBEDDED)

NOT TO SCALE

Addendum 2

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REVISIONS			REVISIONS	DRAWING INFORMATION		
NO.	DATE	BY	DESCRIPTION	N-S PROJECT NO.: 17697.000		
1	9/19/25	RPB	REMOVED RAILING SURFACE MOUNT DETAIL	FILENAME: DETAILS.dwg		
				SCALE: N.T.S.		
				SURVEYED BY: SOUTH COAST GEO		
				DSGN: PKT	DATE: 07/2024	
				DRWN: PKT	DATE: 07/2024	
				CHKD: RPB	DATE: 5/2025	
				QA/QC: GPC	DATE: 8/2025	

LIBRARY PLAZA AND FORREST
AVENUE PEDESTRIAN PLAZA PHASE 2
STP-0210-00(044)LPA/109418-701000
UNIVERSITY OF SOUTHERN MISSISSIPPI
HATTIESBURG, MISSISSIPPI
FORREST COUNTY



SITE DETAILS

WORKING NUMBER: DRAWING NUMBER: 42